City of Austin Residential Permit Application Residential Review, 2nd floor, One Texas Center 505 Barton Springs, Austin, TX 78704 (512) 978-4000

	Project Information
Project Address: 3205 4 berty st 78705	Tax Parcel ID: 837044
Legal Description: Lot a BLKA Ubliffy Adam	
Zoning District or PUD:	Lot Size (square feet): 6348
Neighborhood Plan Area (if applicable):	Historic District (if applicable):
Is this site within the Residential Design and Compatibility Standards C Note: Boundaries are defined under Title 25-2 Subchapter F of the Land Development	Lode.
Does this site currently have water availability? If no, contact Austin Water Utility to apply for water/wastewater taps and/or service ed	wastewater availability?
Does this site have or will it have an auxiliary water source? Y N (Auxiliary water supplies are wells, rainwater harvesting, river water, lake water, reclaim	If yes, submit approved auxiliary and potable plumoning plans
Does this site have a septic system?	If yes, submit a copy of approved septic permit to construct
Does this site require a cut or fill in excess of four (4) feet?	\square_{Λ}
If yes, contact the Development Assistance Center for a Site Plan Exemption Does this site front a paved street? Y	Is this site adjacent to a paved alley?
Does this site have a Board of Adjustment (BOA) variance? Y	Case #(if applicable)
Does this site have a Residential Design and Compatibility Commission of the provide a copy of decision sheet. Note: A permit cannot be approved within	10 days of approval of a variance from BOA.
Does the project impact a tree protected by ordinance? This includes ca	anopy and/or critical root zone impacts to nearby trees.
Note: If yes, application for a tree permit with the City Arborist may be required.	<u> </u>
Is this site within one hundred-fifty (150) feet of the one hundred (100) Note: Proximity to a floodplain may require additional review time.	year floodplain?
Note: Fromme, to a moodpain may equive	Description of Work
Existing Use: vacant single-family residential duplex residential	
Proposed Use vacant single-family residential duplex residential	
Project Type: new construction addition addition/rem	
# of existing bedrooms: # of bedrooms upon completion: #	of existing baths: # of baths upon completion:
Will all or part of an existing exterior wall be removed as part of the pr	roject? Y N
Note: Removal of all or part of a structure requires a demolition permit. Project Description: (Note: Please provide thorough description of project. Attach	additional pages as necessary)
New Construction SF 2 Story house of Sundects & ATTIC Studio.	carport countelparing
DVI (CUT) BATTILL	
m i p i l Educii Educiia	echanical (HVAC)
(circle all that apply)	
	Job Valuation
Total Job Valuation: \$ 330K Portion of Total Job Val	
Bldg: \$ 300K Ele	ec: \$ 10K
Note: The total job valuation should be the sum total of all valuations noted to the right. Labor and	Bldg: \$ Elec: \$ \$ Plmbg: \$ Mech: \$
materials only, rounded to nearest dollar Permit fees are based on adopted fee schedule. Primary Structure: Accessory Structure:	\$1 mog. \$

	Building and	Site Area
Area Description Note: Provide a separate calculation for each distinct area. Attach additional sheets as necessary. Measurements are to the outside surface of the exterior wall. Existing Sq F	t New/Added Sq Ft	Total Sq Ft
a) 1 st floor conditioned area	1403	1403
b) 2 nd floor conditioned area	11.36	1136
c) 3 rd floor conditioned area	208	208
d) Basement		
e) Covered Parking (garage or (arpo)t) 100	200	200
f) Covered Patio, Deck or Porch 412	412	412
g) Balcony 215/3/0	535	535
h) Other		
i) Uncovered Wood Deck		
Total Gross Building Area (total A through I)	3694	3694
j) Pool		
k) Spa		<u> </u>

Site Development Information				
Building Coverage Information Note: Building Coverage means the area of a lot covered by buildings or roofed areas, but excludes ground level paving, landscaping, open recreational facilities, incidental projecting eaves, balconies, and similar features. Pools, ponds, and fountains are not included in this measurement. (LDC 25-1-21)				
Total Building Coverage (sq ft): 2015 % of lot size: 31.1				
Impervious Cover Information Note: Impervious cover is the total horizontal area of covered spaces, paved areas, walkways, and driveways. The term excludes pools, ponds, fountains, and areas with gravel placed over pervious surfaces that are used only for landscaping or by pedestrians. For an uncovered wood deck that has drainage spaces between the deck boards and that is located over a pervious surface, 50 percent of the horizontal area of the deck is included in the measurement of impervious cover. (LDC 25-1-23)				
Total Impervious Cover (sq ft): 2141 % of lot size: 43.2				
Setbacks Are any existing structures on this site a non-compliant structure based on a yard setback requirement? [LDC 25-2-513]				
Does any structure (or an element of a structure) extend over or beyond a required yard? (LDC 25-2-513)				
Is front yard setback averaging being utilized on this property? (LDC 25-2, Subchapter F, Sec. 2.3)				
Height Information (LDC 25-1-2) or 25-2 Subchapter F, Section 3.4) Parking (LDC 25-6 Appendix A & 25-6-478)				
Building Height: 32 ft Number of Floors: 2 # of spaces required: 2 # of spaces provided: 2				
Right-of-Way Information Is a sidewalk required for the proposed construction? (LDC-6-353) *Sidewalks are to be installed on any new construction of a single family, two-family or duplex residential structure and any addition to an existing building that increases the building's gross floor area by 50 % or more.				
Will a Type I driveway approach be installed, relocated, removed or repaired as part of this project?				
Width of approach (measured at property line):ft Distance from intersection (for corner lots only):ft				
Are storm sewer inlets located a ong the property or within ten (10) feet of the boundaries of the property? Y				

the state of the season of the				Subchapter	H-'McMansion'
Gross Floor Area This section is only required for projects Subchapter F of the Land Development Code with ceiling height over 15 feet are counted to	. The Gross Floor Area of eac	ign and Compati	pility Standards Ordir ed as the area contair	nance Boundaries as defined within the outside ed	ned and illustrated in Title 25-2 ge of the exterior walls. Areas
	Existing	New	Exemption	Total	
1 st Floor		1403		1403	
2 nd Floor		1136		1130	
3 rd Floor		205		205	
Basement					
Attic		208	-208	208	
Garage (attached)				
(detached	d)				•
Carport (attached	i)	200	-200	100	
(detache	ed)				
Accessory buildi (detache					
Ceilings over 15	ft				
	тот А	L CDOSS FI	LOOR AREA	apper	
	1014	L GROSS F	LOOK AREA	2539	
		3	9.9	0301	
То	tal Gross Floor Area /lo	t size) =	Mh Floor-To	o-Area Ratio (FAR)
Is this project claiming a "parking a Is this project claiming a "ground fill Is this project claiming a "basemen Is this project claiming a "habitable Is a sidewall articulation required for Does any portion of the structure examples and ceilings over 15 feet in hei	loor porch" exemption a t" exemption as describe e attic" exemption as des or this project? xtend beyond a setback	s described under Artic scribed under	ider Article3? de 3?	Y Y Y Y Y Y	

Parking Area exemption: Up to 450 square feet of a parking area may be deducted if it is a detached rear parking area that is separated from the principal structure by not less than 10 feet; or attached by a covered breezeway that is completely open on all sides, with a walkway not exceeding 6 feet in width and a roof not exceeding 8 feet in width; or a parking area that is open on two or more sides, if: it does not have habitable space above it; and the open sides are clear and unobstructed for at least 80% of the area measured below the top of the wall plate to the finished floor of the carport. Up to 200 square feet may be deducted if it is an attached parking area used to meet the minimum parking requirement; or a garage that is less than 10 feet from the rear of the principal structure, provided that the garage is either detached from the principal structure; or attached by a covered breezeway that is completely open on all sides, with a walkway not exceeding 6 feet in width and a roof not exceeding 8 feet in width. An applicant may receive only one 450-square foot exemption per site under Article 3. An applicant who receives a 450-square foot exemption may receive an additional 200-foot exemption for the same site under Article 3, but only for an attached parking area used to meet minimum parking requirements.

Ground Floor Porch exemption: A ground floor porch, including a screened porch, may be exempted, provided that the porch is not accessible by automobile and is not connected to a driveway; and the exemption may not exceed 200 square feet if a porch has habitable space or a balcony above it.

Basement exemption: A habitable portion of a building that is below grade may be exempted if the habitable portion does not extend beyond the first-story footprint and is below natural or finished grade, whichever is lower; and it is surrounded by natural grade for at least 50% of its perimeter wall area and the finished floor of the first story is not more than three feet above the average elevation at the intersections of the minimum front yard setback line and the side property lines.

Habitable Attic exemption: A habitable portion of an attic may be exempted if: 1. The roof above it is not a flat or mansard roof and has a slope of 3 to 12 or greater; 2. It is fully contained within the roof structure; 3. It has only one floor; 4. It does not extend beyond the footprint of the floors below; 5. It is the highest habitable portion of the building, and adds no additional mass to the structure; and 6. Fifty percent or more of the area has a ceiling height of seven feet or less.

City of Austin Residential Permit Calculation Aid Residential Review, 2nd floor, One Texas Center 505 Barton Springs, Austin, TX 78704 (512) 978-4000

3205 Uberton

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			F F F F P A SURK Sea.	and Site Area
Area	Description			central street with extrem
Note: Provide a separate calculation for	each distinct area. Attach additional sheets as	Existing Sq Ft	New/Added Sq Ft	Total Sq Ft
1 1 1 1 1 1 1 1 1 1 1 1 1 1 1 1 1 1 1	the outside surface of the exterior wall.	8-1	Nem Added 34 M	Total Sq Ft
ii. 2 nd floor conditioned a	Sales and the sales are sales and sales are sales are sales and sales are sa		1463	1403
iii: 134 floor conditioned a	Ca	1136	1136	1136
iv. Basement		A A THE PART OF	208	708
V Attached Covered Rark	INC. Catagoria Caranti Cara			
VI. Detached Covered Park	(IDO (garage or compant)	64	700	200
VIIII Covered Wood Decks	counted at 100% No.	Process of the same of the	EA, TOO WAY THE TOTAL A	
VIII. Covered Patio / Porch /	dengrated values 4110	The state of the s		in
:> 1XN u#≅ Balconya : = _ = v= u = .		WALL TO THE PROPERTY OF THE PERSON OF THE PE	412	412
x. Other – Specify:			15.85	535
Total Building Area (TBA)	(addyi through x ₁)	b) 10 10 10 10 10 10 10 10 10 10 10 10 10	tang,	7.5
The second secon	C) (from TBA subtract, if applicable:	On the same	3359	3359 38
Danning Coverage (11)	ii., iii, iv., and vii if uncovered)			2550
xi Dřiveway	(in the covered)	(A)	2015	2015 (B)
xii. Sidewalks	100 100 100 100 100 100 100 100 100 100		166	145
XIII, P. Uncovered Patro		2160/2124C-1250-1100-1100-1100-1100-1100-1100-1100	20 207	
1 XIV. Uncovered Wood Decks	(counted at 500/)		535	- 535
XY. 12. AC pads and other conc	reterflatwork		a una como como como como	· Cu alla alla alla alla alla alla alla a
xvi. Other (Pool Coping, Ret	dining Walls)	· · · · · · · · · · · · · · · · · · ·	1 32	32
Total Site Coverage	(add: TBC and xil through xvi.)		32 Table 250 1992 150	"The stude" ma
xvii. Pool	The state of the s		2141	2747 (D)
xviii 4 Spa 34 14 14 15				
		LALL A TO 1 DE	THE MAN THE	#950 A Transition
Building Coverage Information			te:Develojament	annon manion.
incidental projecting caves balconies and	f a lot covered by buildings or roofed areas, but milar features. Pools, ponds, and fountains ar	excludes ground level navir	ng landscaning open recreat	ional facility-
1	milar features. Pools, ponds, and fountains ar	e not included in this measu	rement. (LDC 25-1-21)	ional facilities,
Lot Area (sq n):				
Existing Building Coverage (see	above A, sq ft):	Evicting Covers		
Final Building Coverage (see ab	D - 00 00 00		of lot $(\underline{\mathbf{A}} + \mathbf{Lot} \ \mathbf{area}) \times \mathbf{I}$	
Impervious Cover Information	ove <u>n</u> , sq 1():	inal Coverage % of lo	ot $(\underline{\mathbf{B}} + \mathbf{Lot} \text{ area}) \times 100$: 31.7%
National Cover Information	-			

Note: Impervious cover is the total horizontal area of covered spaces, paved areas, walkways, and driveways. The term excludes pools, ponds, fountains, and areas with

Existing coverage % of lot ($\underline{C} \div Lot area$)x100:

Final coverage % of lot (\underline{D} + Lot area)x100 : 43.2%

gravel placed over pervious surfaces that are used only for landscaping or by pedestrians. (LDC 25-1-23)

2013

Existing Impervious Coverage (see above C, sq ft):

Final Impervious Coverage (see above <u>D</u>, sq ft):

		Contact Information		
Owner Rainbow	Bend Properties Agent	Hustor to some		
Mailing Address	Mailing Address	1008 South Centr St		
Phone	Phone	791-0517		
Email Fax	Email Fax	hectorconsulting Gent		
General Contractor	Design Professional	Design Originals ofTexa		
Mailing Address	Mailing Address	Design Originals oflexion		
Phone	Phone	512 331-1775		
Email Fax	Email Fax			
		Acknowledgments		
	2. Leave to a few the comment to a second with the co	previous district?		
	r's homestead for the current tax year with the appropriate Sections 25.1.411 and 25.11.66 of the Land	d Development Code (LDC), non-compliance with the		
LDC may be cause for the Buildi	ing Official to suspend or revoke a permit and/or	license.		
I understand that I am responsible prohibiting certain uses and/or re	le for complying with any subdivision notes, requiring certain development restrictions (i.e., he	strictive covenants and/or zoning conditional overlays ight, access, screening, etc.) on this property.		
provide copies of all subdivision	ny of these restrictions, it will be my responsibility plat notes, restrictive covenants, and/or zoning	ity to resolve it. I understand that, if requested, I must conditional overlay information that may apply to this		
property. I acknowledge that this project qualifies for the Site Plan Exemption as listed in Section 25-5-2 of the LDC. I understand that nothing may be built upon or over an easement.				
I further understand that no porti	ion of any roof structure may overhang in any pof any necessary relocation of existing utilities t	ublic utility or drainage easement. I acknowledge that o clear this driveway location and/or the cost to repair		
I agree that this application vapproved and an extension is current code may be required.	vill expire on the 181st day after the date the not granted. If the application expires, a ne	nat the application is filed if the application is not we submittal will be required and compliance with		
· · ·	f my knowledge and ability, the information pro	vided in this application is complete and accurate.		
I further acknowledge that, should any information contained herein prove incorrect, the building official may suspend or revoke any resulting permit and/or license.				
I also understand that if there are any trees greater than 19 inches in diameter located on the property and immediately adjacent to the site, I am required to complete a Tree Ordinance Review Application by contacting (512) 974-1876 or cityarborist@austintexas.gov. This initiates the tree permitting requirement needed to proceed with the development review process.				
Erosion and Sedimentation Controls are required per Section 25-8-181.				
I acknowledge that a sidewalk will be required on any new construction of a single family, two-family or duplex residential structure and any addition to an existing building that increases the building's gross floor area by 50 % or more.				
I acknowledge if my plans are su any of the provisions of the curre	bject to a technical review it will not be construent adopted building codes or another ordinance	ed to be a permit for, or an approval of any violation of of the City of Austin.		
1	A o A	10 0 1//		
Applicant's signature:	75-C	Date: 12 - 7 - 14		



Water & Wastewater Service Plan Verification (WWWSPV)

Service Address: 3205 LIberty
Lot: 2 Block: A Subdivision: LIbrary Addy
Existing Use: Vacaut
Proposed Use: Single Family Res. Two-Family Res. Duplex Mobile Home Secondary Apt. Cottage Urban Home
Guest House Accessory Dwelling Accessory Apt. Other
Existing # Baths Additional # Baths Total number of bathrooms the meter will serve 3
Helder Aviva 12/8/14 791:05/7
Applicant's Name & Title 12/8/14 791.0517 Phone
City of Austin Office Use
Water main size Service stub size Service stub upgrade required: Y N
Shared Dual Service? Y (N) If yes, state meter size(s) on shared service
Existing meter # NONE Existing meter size
Existing water service line/meter location NONE
Upgrade required: (Y) N New meter(s) size 5/8 "
WW main size WW Service line/clean-out location NONE
Secondary address needed at property: Y N
AWU Pipeline Engineering approval required: (Y) N
Utility Tap Plan required: Y N
comments: Services to the installed by customer
DEC 0 8 2014
THE BY
AWU Engineer Representative AUSTIN WATER UTILITY CONSUMER SERVICE DIVISION - TAPS Date Phone
AWU Taps Representative Date Phone

Water meters & wastewater clean-outs are not permitted in sidewalks or driveways.

Relocation of services to remove them from proposed sidewalks or driveways shall be performed at the applicant's expense.

If the existing water meter was pulled for non-billing account during demolition contact Customer Care at 512-494-9400 to have account set up and the same size meter reinstalled within 120 days of meter removal (with active building permit) to avoid city reconnect charges being applied.



One Stop Shop 505 Barton Springs Rd (512) 974-2632 – phone (512) 974-9112 – phone (512) 974-9109 – fax (512) 974-9779 – fax

Austin Energy Building Service Planning Application (BSPA)

This form to be used for review of Building Permit only

Residential Project Address Legal Description Who is your electr Overhead Serv	for Service Request Hector Arius Sultinge lands link run Fax Phone 19(0)57 Commercial New Construction Remodeling OR Lot 2 Block A rical provider? AE Other rvice Underground Service Single-phase (10) Three-phase (30)
Location of meter	ng meters on gutter (show all existing meters on riser diagram)
Evnired permit #	
Comments	New (2) Story House
Hector ESPA Complete	ANA 12/8/14 50.79/05/17 ed by (Signature & Print Name) Date Phone
AE Representati	tive Approved Yes No Date Phone

Application expires 180 days after the date of approval (Any change to the above information requires a new ESPA)

All structures etc. must maintain 7'5" clearance from AE energized power lines. Enforced by AE & NESC codes.

DEC 0 8 2014


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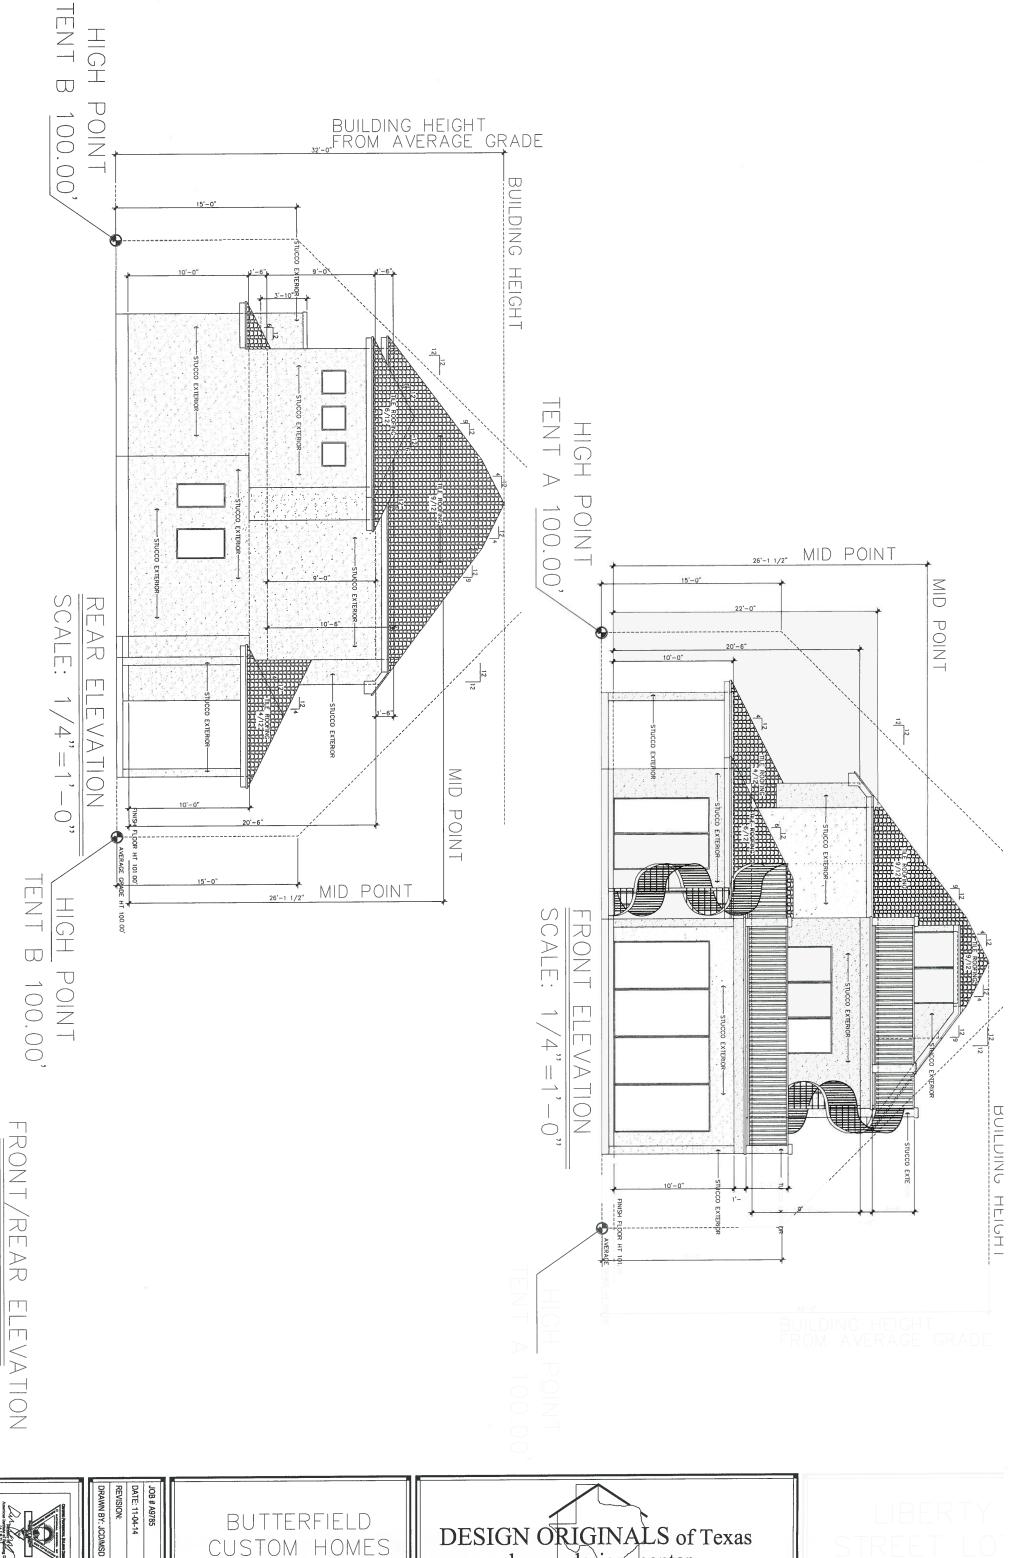
JGM

Revised 2/14/2012

OWNER'S AUTHORIZATION LETTER

operty Address:	berty St			·
#:				
menter by	1 alais	12-08-20	14	
ner's Signature		Date		



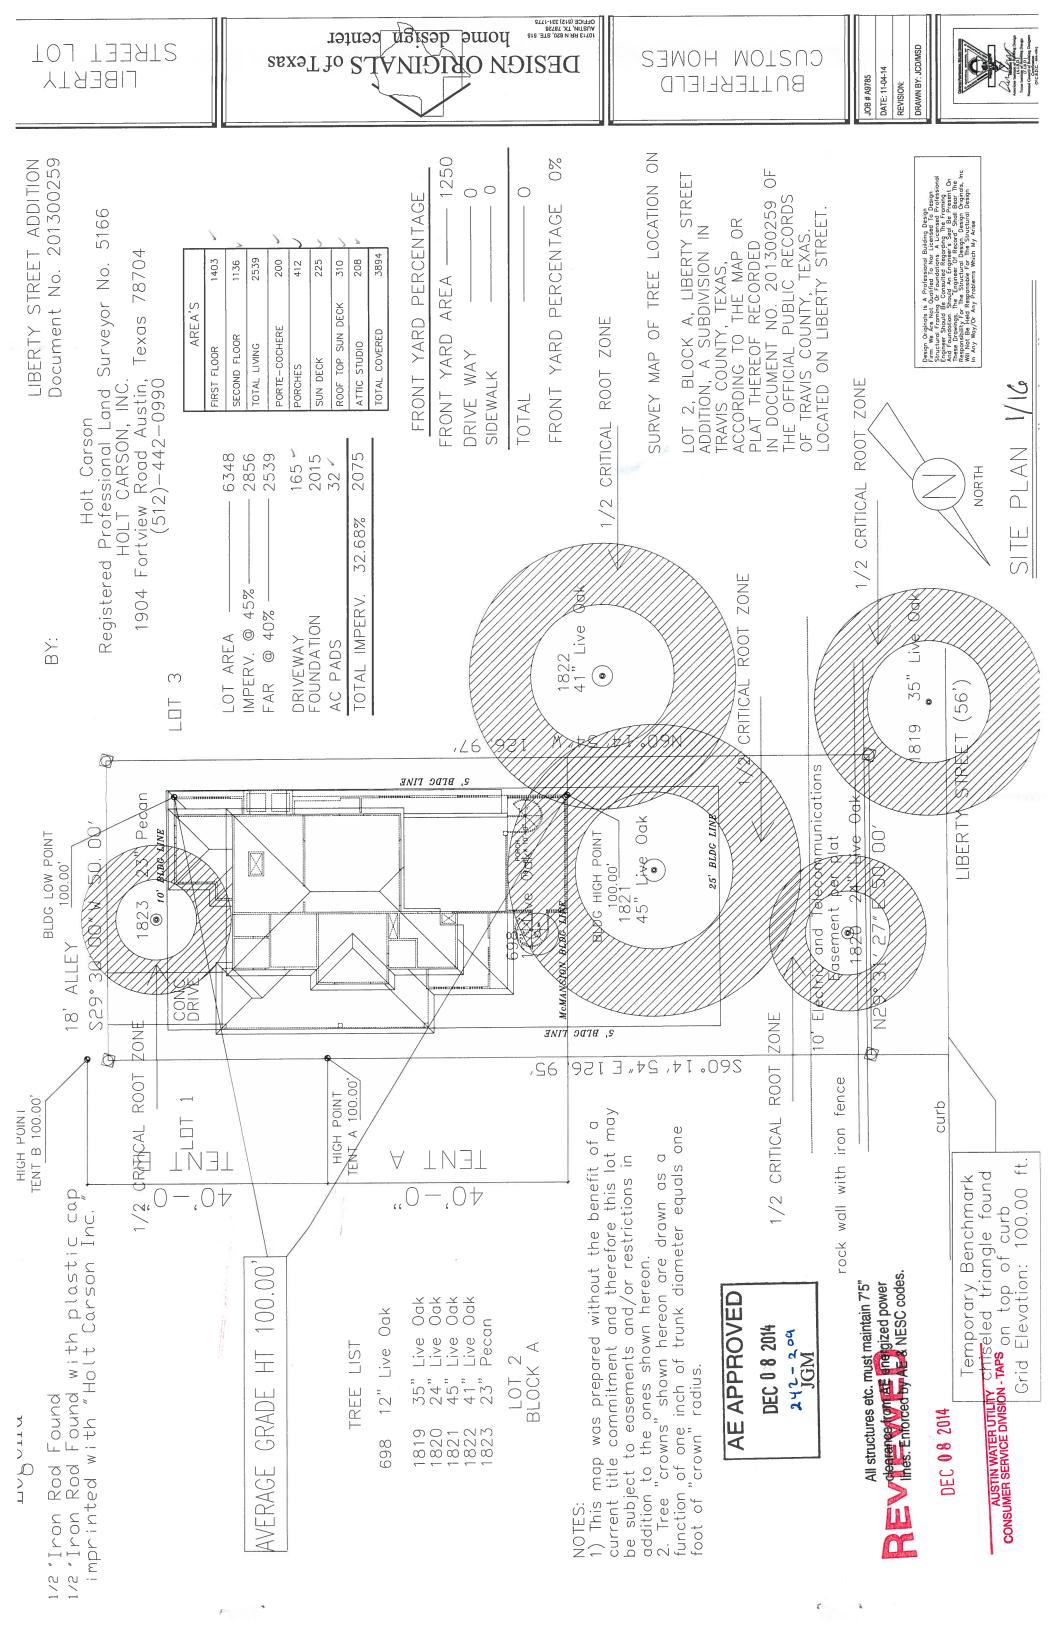


BUTTERFIELD CUSTOM HOMES

DESIGN ORIGINALS of Texas

AS RR N 820, STE 5 home design center

(13) RR N 820, STE 5 home design center

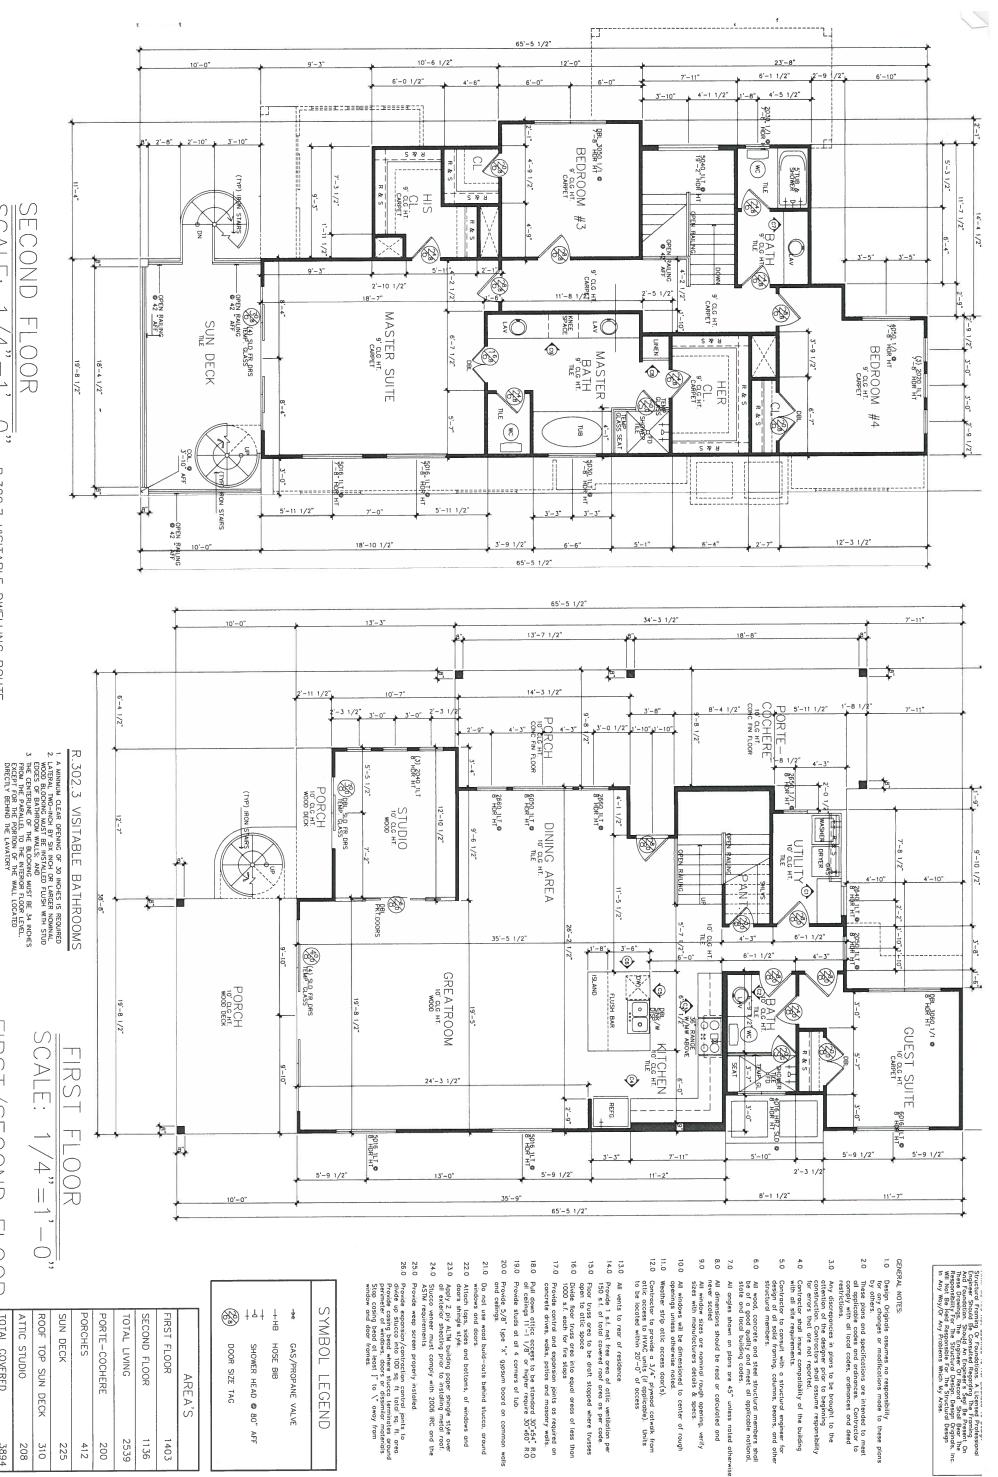

 $S \cap A$ RS T SECOND

TOTAL COVERED

ATTIC STUDIO

208

3894

ROOF

SUN DECK

R.320.7 VISITABLE DWELLING ROUTE

.320.6 VISITABLE DWELLING ENTRANCE

A DWELLING MUST BE ACCESSIBLE BY AT LEAST ONE NONSTEP

A VISITABLE ENTRANCE APPROVED UNDER SECTION R320.6
MUST HAVE AT LEAST ONE VISITABLE ROUTE WITH A CROSS SLOPE

PORTE-COCHERE SECOND FLOOR TOTAL LIVING FIRST FLOOR TOP SUN DECK AREA'S 1136 2539 1403 310 225 412 200

> DATE: 11-04-14 JOB # A9785

DRAWN BY: JCD/MSD REVISION:

AFF BUTTERFIELD


CUSTOM HOMES

HH+ *

DOOR SIZE TAG SHOWER HEAD @ 80" GAS/PROPANE VALVE

SYMBOL LEGEND



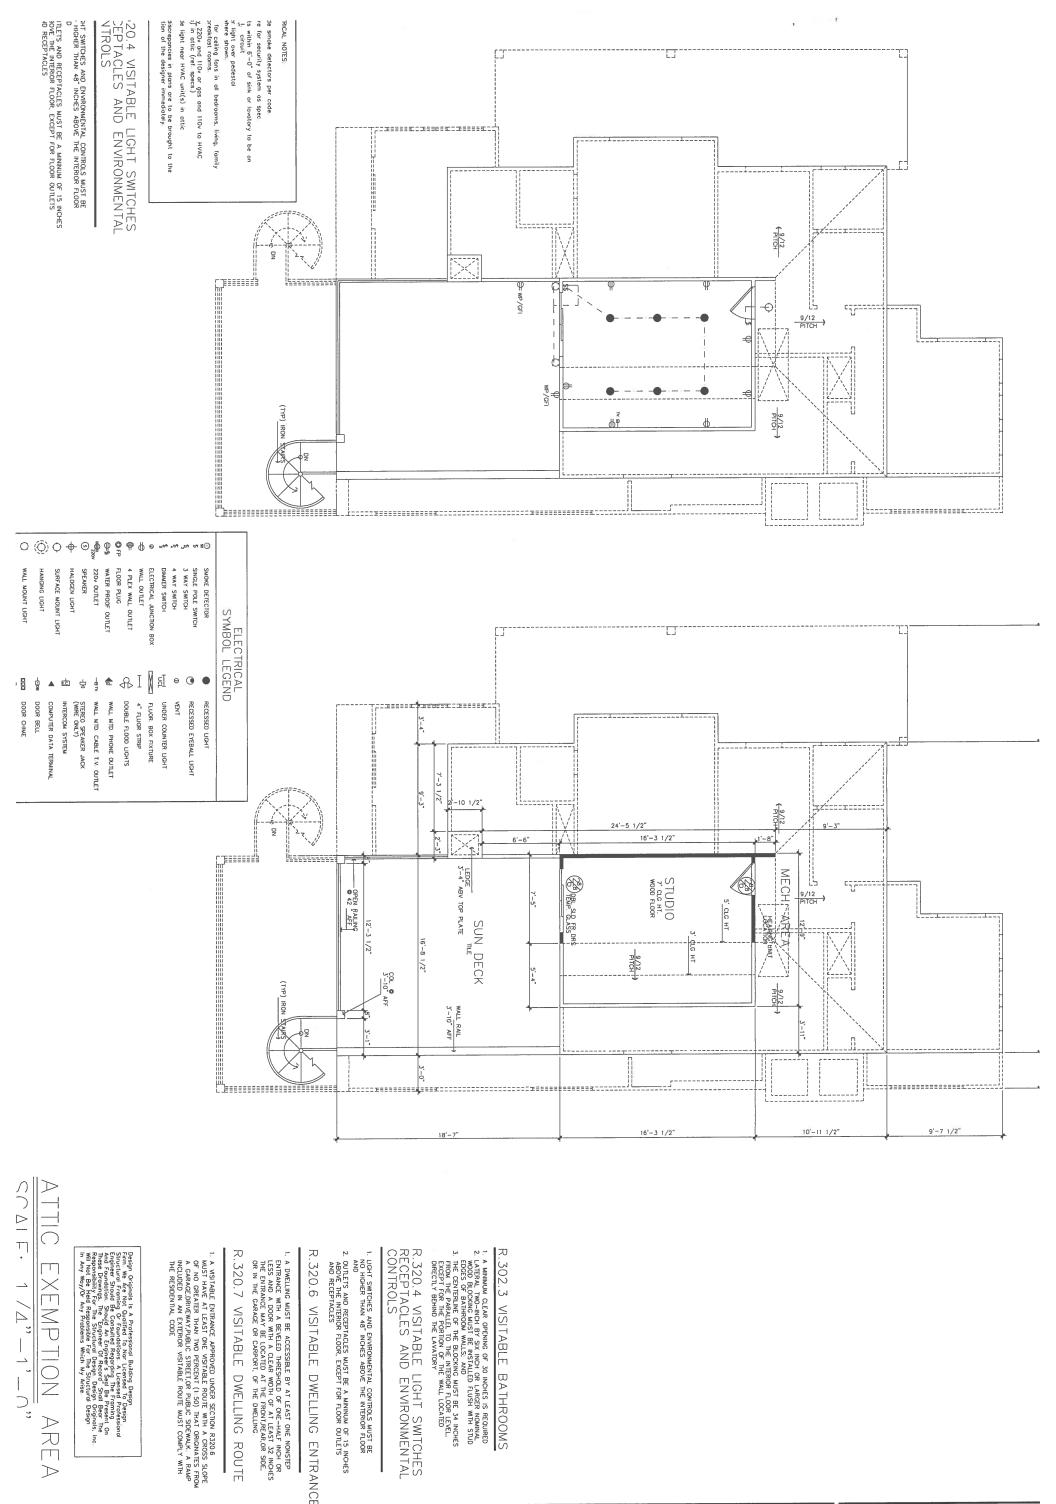

Amount start () for the land true

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JOB # A9785 DATE: 11-04-14


REVISION: DRAWN BY: JCD/MSD

BUTTERFIELD CUSTOM HOMES DESIGN ORIGINALS of Texas

10713 RR N 820, STE. 515
AUSTIN, TX. 78728
OFFICE (512) 331-11775

home design center

LIBERTY STREET LO

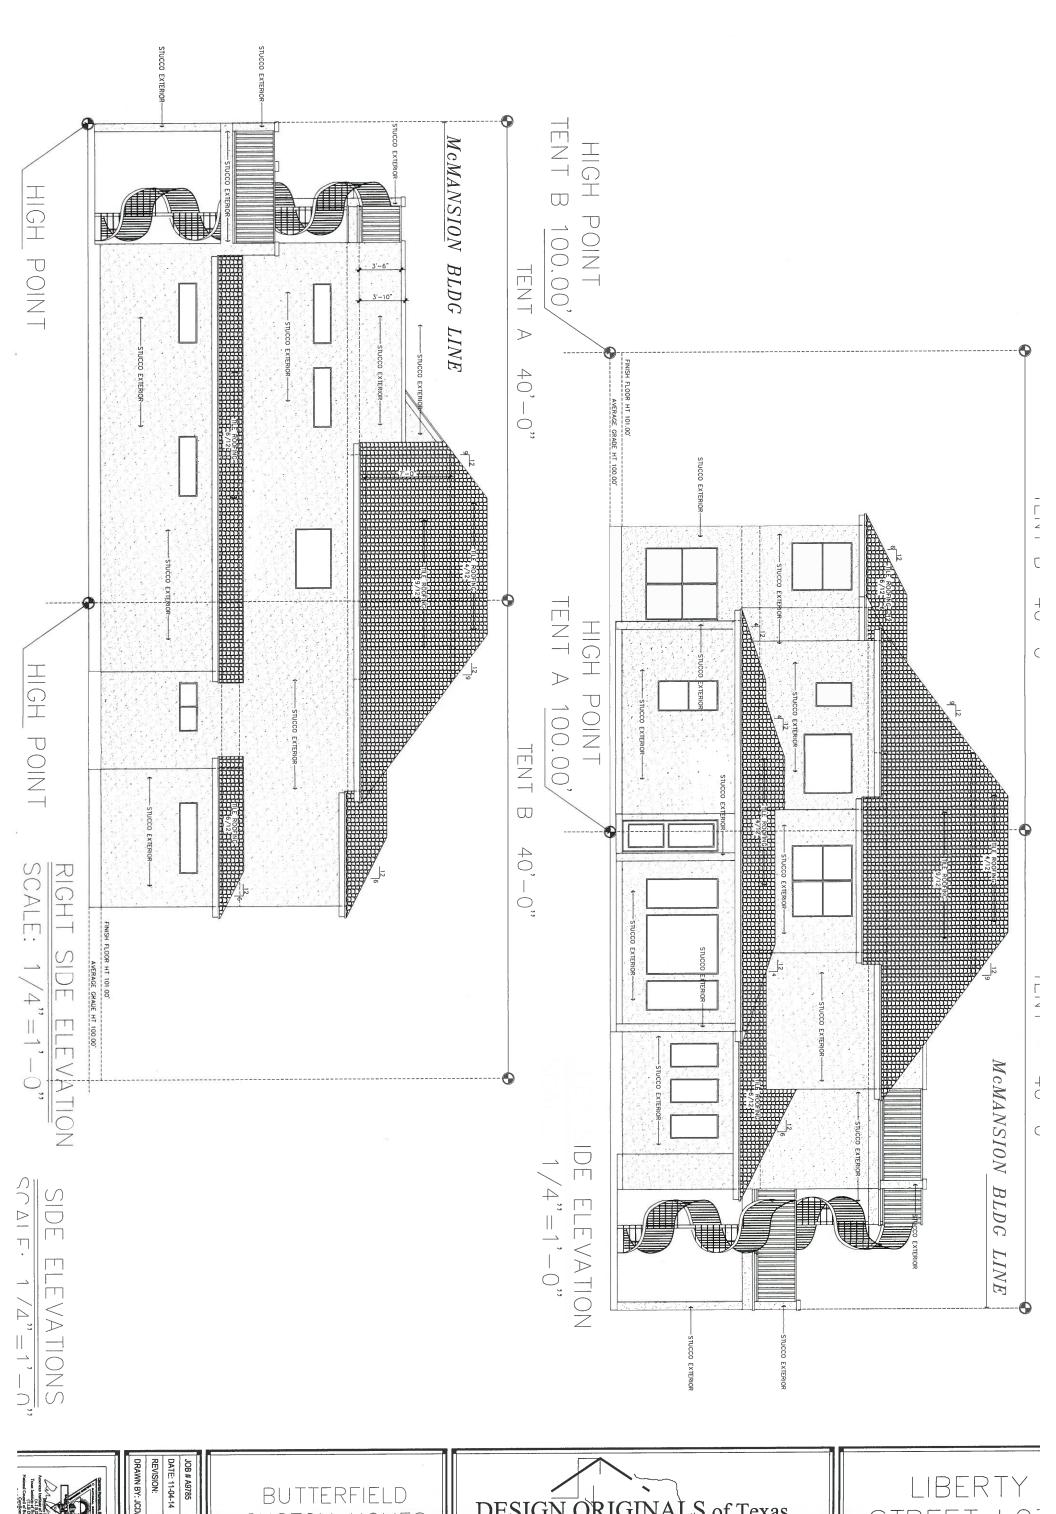



DRAWN BY: JCD/MSD REVISION:

BUTTERFIELD CUSTOM HOMES



4 PLEX WALL OUTLET FLOOR PLUG WATER PROOF OUTLET

ELECTRICAL JUNCTION BOX DIMMER SWITCH SINGLE POLE SMTCH
3 WAY SMTCH
4 WAY SMTCH

LIGHT SWITCHES AND ENVIRONMENTAL CONTROLS MUST BE NO HIGHER THAN 48" INCHES ABOVE THE INTERIOR FLOOR AND OUTLETS AND RECEPTACLES MUST BE A MININUM OF 15 INCHES ABOVE THE INTERIOR FLOOR, EXCEPT FOR FLOOR OUTLETS AND RECEPTACLES

R.320.4 VISITABLE LIGHT SWITCHES RECEPTACLES AND ENVIRONMENTAL CONTROLS


Supply 220v and 110v or gas and 110v to HVAC unit(s) in attic (ref. specs.)
Provide light near HVAC unit(s) in attic Block for ceiling fans in all bedrooms, living, family and breakfast rooms. Center light over pedestal lav, where shown. Provide smoke detectors per code.
Prewire for security system as spec.
Outlets within 6"-0" of sink or lavatory to be an G. F. L. circuit Any discrepancies in plans are to be brought to the attention of the designer immediately.

ELECTRICAL NOTES:

CARBON MONOXIDE DETECTOR

WALL MOUNT LIGHT HANGING LIGHT SURFACE MOUNT LIGHT

SCALE: TO S

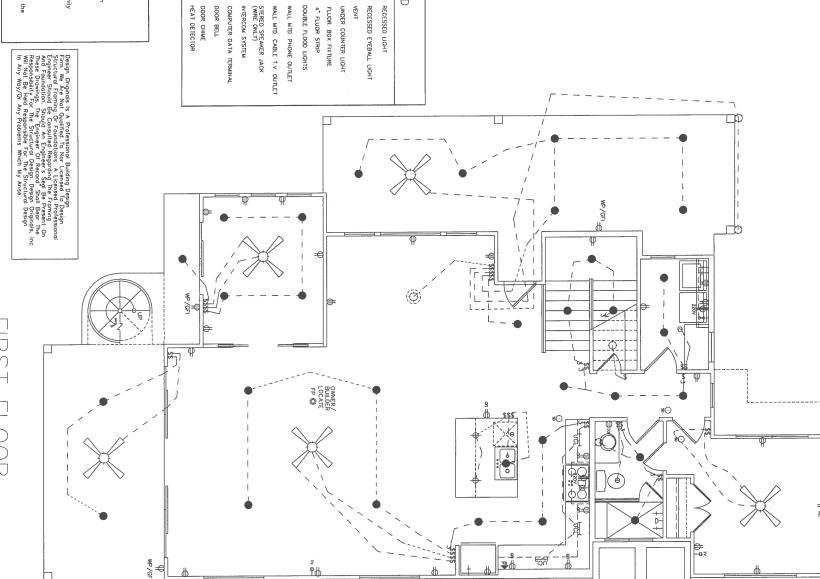

ELECTRICAL SYMBOL LEGEND

RO 1/80

ECTRICAL

JOB # A9785

DATE: 11-04-14


REVISION: DRAWN BY: JCD/MSD

BUTTERFIELD CUSTOM HOMES

DESIGN ORIGINALS of Texas

10713 RR N 820, STE. 515
AUSTIN, TX 78728
OFFICE (512) 331-11775

home design center

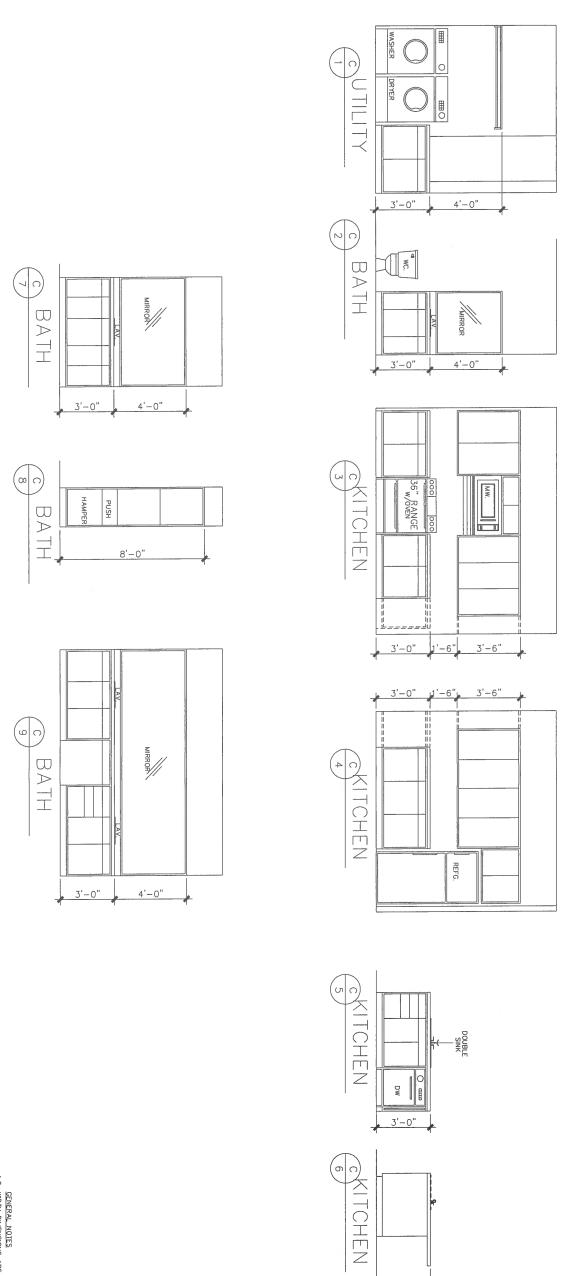

CABINE 3 3/8"=1'-0" EVATIONS

GENERAL NOTES

ON DITH DIMENSIONS ARE APPROXIMATE MEASURE
ON SITE FOR EXACT WIDTH OF CABINET AREAS.

2.0 STANDARD STILES BETWEEN DOORS & DRAWERS
ARE SHOWN CHECK WITH BUILDER FOR EXACT

STILE PLACEMENT & WIDTH.

3.0 STANDARD DOORS & DRAWERS ARE SHOWN CHECK
WITH BUILDER FOR EXACT DOOR & DRAWER FRONTS
& PULLS

4.0 SHELVES ARE SPACED EQUALLY UNLESS NOTED.

5.0 ALL HEIGHTS OF MIRRORS ARE STANDARD CHECK
WITH BUILDER FOR EXACT DIMENSIONS.

6.0 LAVATORIES AND SINKS SHOWN DO NOT REPRESENT
ACTUAL CONFIGURATION. CHECK WITH BUILDER FOR
EXACT SIZE AND SHAPE.

7.0 APPLIANCE DIMENSIONS MAY VARY. CHECK WITH
BUILDER FOR EXACT DIMENSIONS.

DATE: 11-04-14 JOB # A9785 DRAWN BY: JCD/MSD REVISION:

BUTTERFIELD





3'-0"

BERTY

Firm. We Are Not Qualified To Nor Licensed To Design Structural Framing Or Foundations. A Licensed Professional Engineer Should Be Consulted Regarding The Framing And Foundation. Should An Engineer's Seal Be Present On These Drawings. The "Engineer Of Record" Shall Bear The Responsibility For The Structural Design. Design Originals, Inc. Will Not Be Held Responsible For The Structural Design in Any Way/Or Any Problems Which My Arise.

CUSTOM HOMES

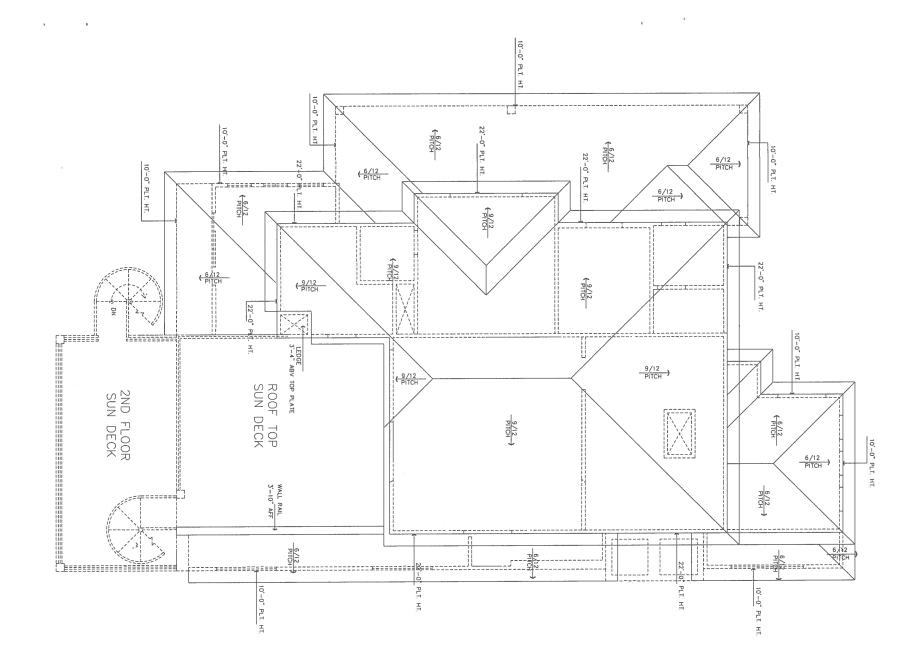

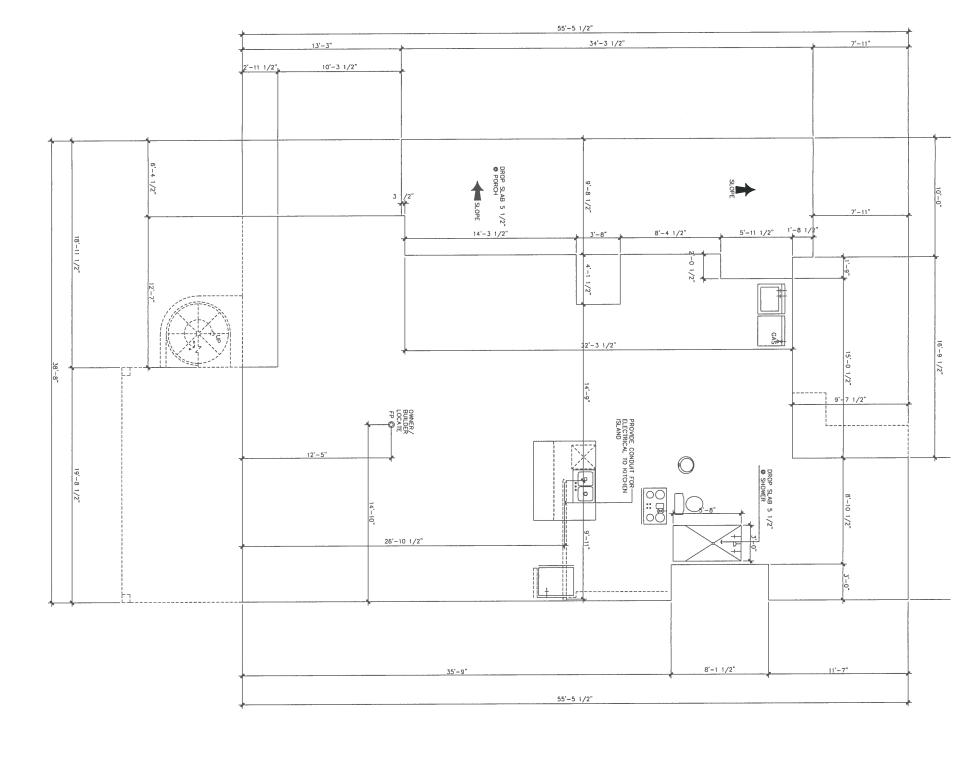



JOB # A9785

DATE: 11-04-14

REVISION:

DRAWN BY: JCD/MSD


BUTTERFIELD CUSTOM HOMES DESIGN ORIGINALS of Texas

10713 RR N 820, STE. 515
AUSTIN, TX, 78726
OFFICE (512) 331-1775

home design center


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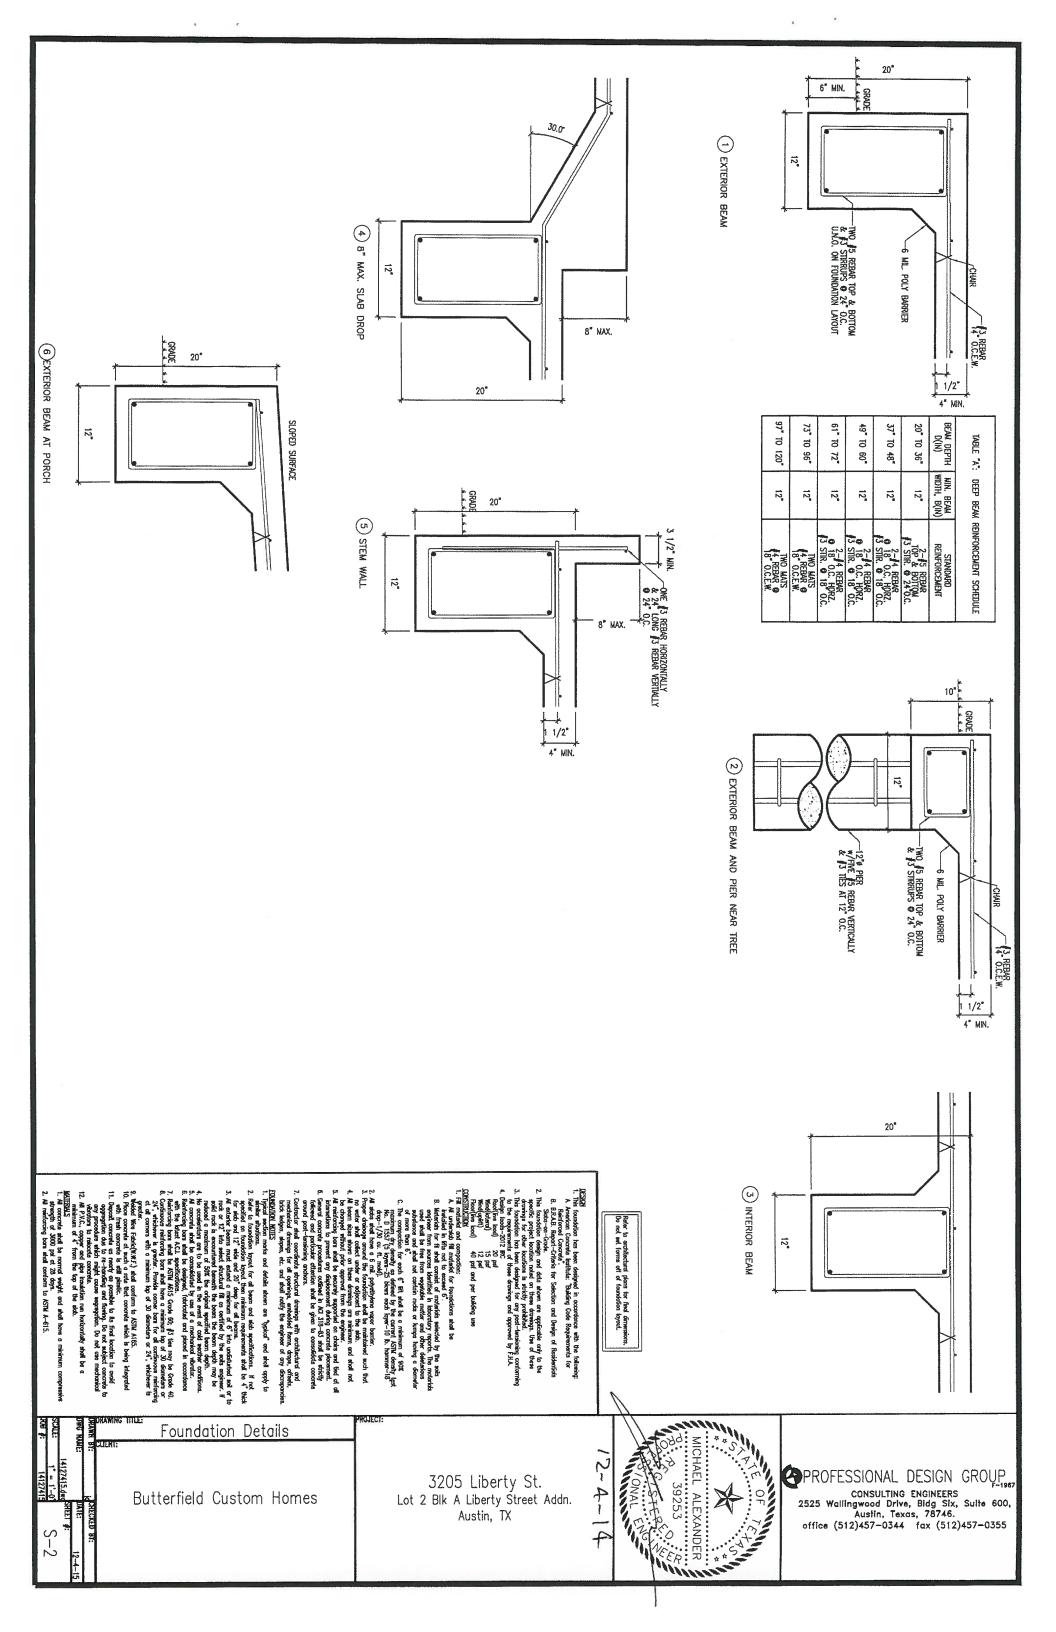
STOP ABBREVIATIONS ABOVE CONTINUES ANCHOR BOLT C /COND CONDUTE ANCHOR BOLT C /COND C CONCERT ANCHOR C /CONCERT ANCH	40 UNAMBIGUOUS, THE REALTY OF THE STIVATION IS THAT IT IS NOT COST- FECTIVE FOR A CLIENT TO PAY A DESIGN REPORTSOMAL FOR THE LEVEL, OF FENCE RECESSARY TO ACHIEVE A "PERFECT" SET OF INSTRUMENTS OF SERVICE: 40 WATER HOW EXCENSE DESIGN SERVICES MAY BE CERTAIN ASPECTS OF IE DESIGN HILL RECOME MODIFICATIONS TO RELECT CONDITIONS AT THE MISTRUCTION STIE CONSTRUCTION IS NOT AMARICALIJANG. THERE IS NO ABUITY J RETINE THE PROJECT PROTOTIVES, DESTRUCTION ITSING, AND RODSON J SERVING PROJECTS SO THAT CHANGE MILL MEROVE THE OUTCOME. MISTRUCTION PROJECTS SO THAT CHANGE MILL MEROVE THE OUTCOME. MISTRUCTION PROJECTS SO THAT CHANGE MILL MEROVE THE OUTCOME. MISTRUCTION PROJECTS SO SOULD BE MEMERIANTLY CALLED TO THE TENTION OF THE APCONTECT PRIOR TO PACKELENT OF MATERIALS THE TOPORMATION AND INTENT OF THESE DRAWNING. ENERGHANTION AND INTENT OF THESE DRAWNING. ENERGHANTION AND INTENT OF THESE DRAWNING. ENERGHANTION AND INTENT OF THESE DRAWNING. FINISH FLOOR SHALL SOPE SE FOR A DISTANCE OF 10" TO AN APPROVED WATER DISPOSAL AREA (OR AS NOTED ON GRAWNING FLOOR HIMMAIN MISULATION EDURAN AT IS UNILIZED BUILD UP 18" ABOVE FLOOR HIMMAIN MISULATION EDURAN AT IS UNILIZED BUILD UP 18" ABOVE FLOOR HIMMAIN MISULATION EDURAN AT IS UNILIZED BUILD UP 18" ABOVE FLOOR HIMMAIN MISULATION EDUCATION OF THE PACK CELLOLOSE EXTERIOR WALLS WILL HAVE 1"2PS(+RS) 2-2- R71 244 - R29 CLG - R29 CLG - R30	ED 4° OC	6d* Of BE USED.	ERLAMENT (TO FRAMING): 60 80 00 60 80 100 00 80 100 00 80 100 00 80 100 00 80 100 00 80 100 00 80 100 00 80 100 00 80 100 00 80 80 80 80 80 80 80 80 80 80 80 8	1-6" TRUSSLOK (DIAG TH	WHECTION
DAMETER, PHASE	<u> </u>	LUMBER NOTES (KILN DRIED WOOD) 1 ALL LUMBER SHALL BEAR AN APPROVED GRADING STAMP 2 DRED DRED AND RAFTERS SHALL BE MINMAUM DOUGLAS FIR \$2 OR BETTER. KLIN 3. ALL LUMBER SHALL BE MINMAUM DOUGLAS FIR \$2 OR BETTER. KLIN 4. JUSTS 1006 (REP) 95 1,700,000 WIND 4 OR LESS 1006 (REP) 95 1,000,000 WOOD 4 OR CEATER HAM 4 875 (SINC) 95 1,000,000 WOOD 5 OR CEATER HAM 4 875 (SINC) 95 1,000,000 STUDGERS 100,000 OR PRETIEATED BOTTOM PLATE AT ALL INTERIOR AND FERRING WALLS 5. PROVIDE SOUD BLOCKING AT \$10-0° ADD E FINSH FLOOR AND AT ALL FURR 5. PROVIDE SOUD BLOCKING AT \$10-0° ADD E FINSH FLOOR AND AT ALL FURR 5. PROVIDE SOUD BLOCKING AT \$10-0° ADD E FINSH FLOOR AND AT ALL FURR 5. PROVINGE SOUD BLOCKING AT \$10-0° ADD E FINSH FLOOR AND AT ALL FURR 5. PROVINGE SOUD BLOCKING AT \$10-0° ADD E FINSH FLOOR AND AT ALL FURR 5. PROVINGE SOUD BLOCKING AT \$10-0° ADD E FINSH FLOOR AND AT ALL FURR 5. PROVINGE SOUD BLOCKING AT \$10-0° ADD E FINSH FLOOR AND AT ALL FURR 5. PROVINGE SOUD BLOCKING AT \$10-0° ADD E FINSH FLOOR AND AT ALL FURR 5. PROVINGE SOUD BLOCKING AT \$10-0° ADD E FINSH FLOOR AND AT ALL FURR 5. PROVINGE SOUD BLOCKING AT \$10-0° ADD E FINSH FLOOR AND AT ALL FURR 5. PROVINGE SOUD BLOCKING AT \$10-0° ADD E FINSH FLOOR AND AT ALL FURR 5. PROVINGE SOUD BLOCKING AT \$10-0° ADD E FINSH FLOOR AND AT ALL FURR 5. PROVINGE SOUD BLOCKING AT \$10-0° ADD E FINSH FLOOR AND AT ALL FURR 5. PROVINGE SOUD BLOCKING AT \$10-0° ADD E FINSH FLOOR AND AT ALL FURR 5. PROVINGE SOUD BLOCKING AT \$10-0° ADD E FINSH FLOOR AND AT ALL FURR	4. CROUT - FC=2000 PS 5. REINFORMS STEEL - A-615, FY=40 KS 6. STRUCTURAL STEEL - A-7615, FY=40 KS 6. STRUCTURAL STEEL - A-76, FY=35 KS 7. BQLTS - A-70, FY=33 KS 8. CQUF-LW BEAMS - FB=2400 PS, E=18040 PS, FY=165 PS 9. OREHTED STRAND BAARD COMPOSTE BOARD. 10. PLYMOOD WALL SHEATHING 1/2 STANDARD SHEATHING WITH EXTEROR GLUE PAMEL INDEX 11. PLYMOOD ROOF - 5/8 STANDARD SHEATHING WITH EXTEROR GLUE. PAMEL INDEX 12. PLYMOOD ROOF (FOAM ROOF SYSTEM) 5/8 TAG STANDARD SHEATHING PAMEL INDEX 12. PLYMOOD ROOF (FOAM ROOF SYSTEM) 5/8 TAG STANDARD SHEATHING PAMEL INDEX 12. PLYMOOD ROOF (FOAM ROOF SYSTEM) 5/8 TAG STANDARD SHEATHING PAMEL INDEX 13. PLYMOOD FLOOR - 3/4" TAG STANDARD SHEATHING, PAMEL INDEX 14. USE. OF 23/6 15. PLYMOOD FLOOR - 3/4" TAG STANDARD SHEATHING, PAMEL INDEX 16. STANDARD SHEATHING, PAMEL INDEX 17. OC 18. ROOF** 5/8 TAG 33/6 18. ROOF** 5/8	A PROWIE CUPPEN UPER AN SERVILE ENHANCE (NEWS I MIT ELECTRICADAY) PROWIE Z-14'S IN FOOINISO OVER RETURN ARD DUCTS, SETEMO 17 E CACH SIDE REPLACE FOOTING MINIMUM 18' BELOW UNDSTURBED SOIL WITH MINIMUM 14'S AT 8' OC EACH WAY WHEN MASONEY FREPLACES ARE USED (VERRY WITH FOUNDATION PLAN). PROWDE A NON-SUP SURFACE ON ALL EXTERIOR CONCRETE MATERIAL SPECIFICATIONS L CONCRETE - FC-5000 PS AT 28 DAYS MINIMUM. 3500 PS AT DRIVEWAY MASONEY - FORD S. FM-1800 PS MORTAR - TIPE S. FM-1800 PS MORTAR - TIPE S. FM-1800 PS	이 크	A PEPROVED LEGO. TESTING LIMITS STALL BE CERTIFIED BY A CLIRRENTLY A PEPROVED LEGO. TESTING STANDARD NUMBER 127 (UL 127) AND/OR HAVE AN A COTRE LEGO. TESTING STANDARD NUMBER 127 (UL 127) AND/OR HAVE AN A COTRE LEGO. AND ES PRAILATION REPORTS. AND AND ACTURERS WHITE HERPLACES SHALL BE INSTALLED IN ACCORDANCE WITH THE HANGE ACTURERS WHITE HERPLACES SHALL BE INSTALLED IN ACCORDANCE WITH THE HANGE ACTURERS WHITE HAVE HERE DECORATIVE NON-COMBUSTIBLE FINISH AND ADOUT THE PRE-FAB PREBOX OPENING A HEARTH EXTENSIONS SHALL HAVE THEIR DECORATIVE NON-COMBUSTIBLE FINISH HANTENALS (TO TILE. STONE, MASONRY, ETC.) INSTALLED OVER A THERMAL ESCISTINE BARRIER WHICH COMPLES WHIT THE AMAULACTURERS WHITEN HANTENALS (TO TILE. STONE, MASONRY, ETC.) INSTALLED OVER A THERMAL RESISTINE BARRIER WHICH COMPLES WHITE ME AMAULACTURERS WHITEN HAVE AND
LAM LAMINATE (D) LLM LAMINATE (D) LLM LAMATORY LLM LONG LEG HORIZONTAL LUCHOL LOCATE LDC LOCATE CDC MECHANG MAX MASSURRY PST. POWNOS PER SO GOOT ST. CONTROL ST.	4 DOOR NITO HOUSE FROM CARAGE TO BE TIGHT FITING WITH CASKETS AND SMEED 1 3/4" SOLID CORE. JACUZZI TUB 1. PROWIDE REMOVABLE PANEL OF SUFFICIENT SIZE TO ACCESS PUMP. 2. CIRCULATION PUMP STALL BE LOCATED ABOVE THE CROWN WERR OF THE TRAP. 2. SUCTION FITINGS SHALL CORNELY WITH THE USIED STANDARDS. 3. SUCTION FITINGS SHALL CORNELY WITH THE USIED STANDARDS. 4. SUCTION FITINGS SHALL CORNELY WITH THE USIED STANDARDS. 5. PROWIDE 61 C COTTET FOR PUMP MASONRY NOTES COLUMN BASE & WALL 1. PROWIDE 64 VERTICALS IN SOLID GROUT AT ALL CORNERS, BNDS AND JAMBS AND 4-70" MAXIMUM ELSEWHERE. 2. PROWIDE 64 DEBOND EAW WITH 1-44 CONTINUOUS AT MASONRY PLATE HEIGHT, AT 8-0" ABOVE FINISH FLOOR, AND AT 10P OF ALL PRAPET WALLS. 3. PROWIDE 64-64 VERTICALS IN SOLID GROUTED CELLS AT MASONRY COLUMNS WITH 12 PROVIDE 67 OC C MAZIMUM SPANDED STANDARD EXPANSION JOINTS AT 20"-0" OC MAZIMUM. 5. PROVIDE STANDARD EXPANSION JOINTS AT 20"-0" OC MAZIMUM.	SHALL NOT BE USED IN THE INSTALLATION OF REPAIR OF MAY PLUMBING IN RESIDENTIAL OF NORESCIBENTIAL FACILITIES PROVINCING MEETE FOR HAMAN CONSIGNED FOR WORKESCIBENTIAL FACILITIES PROVINCING MEETE SYSTEMS. 2. PLUMBING REPAIR SEA STRUMS (ORDINANCE FORTSS) WATER CLOSETS 15 GALLOW FER FLUSH MAXIMUM. SHOWER HEAD - 275 GALLOW FER FLUSH MAXIMUM. LIVANTORY/SINK FAUCETS - 3 GALLOW FER HINDITE MAXIMUM. LIVANTORY/SINK FAUCETS - 3 GALLOW FER HINDITE MAXIMUM. LIVANTORY/SINK FAUCETS - 3 GALLOW FER HINDITE MAXIMUM. HOT WATER SHALL BE THE LEFT FITTING AT ALL FAUCETS. 3. COLD-FEX EXITS / DOORS SHALL BE DEAD BOLTED ALL ENTS TO BE OPENABLE FROM THE NEODE WITHOUT USE OF A KEY OF SPECIAL KNOWN FIGE. MANUALLY OPERABLE DOES OF SUFFACE—AUDITED TUSH BOLTS AND SECTION OF THE WORK OF	4 SMOKE DETECTION TO BE CELLING MODINED AND IN CLOSE PRODMITY TO THE STRIMWAY ON UPPERE FLOOR LEVEL (IF PAPLICABLE) 5 PROVIDE A MINIMUM OF ONE SMOKE DETECTION IN THE BASEMENT. (IF 5 PROVIDE ALL SILMAN AND UPPERE FLOOR LEVEL (IF PAPLICABLE) 1 PAPLICABLE) 1 PAPLICABLE 1 PART TO 38" ABOVE STAR NOSING AND DESIGNED SUCH THAT A 4" SPHERE CHANDT PASS THROUGH HAND GRIP PORTION OF HANDRALL(S) SMALL AND THE LESS THAN 1 1/2" IN CROSS SECTIONAL DIMENSION HANDRAL(S) SMALL AND THE HANDRALL HAVE A SPACE OF NOT IEST THAN 1 1/2" IN CROSS SECTIONAL DIMENSION HANDRALS TO PRETIDED OR TERMINATE AT INFINITY AND THE HANDRALL BADE SHALL BE RETURNED OR TERMINATE AT INFINITY AND ON A HOROZONTAL BRADBALS 72" PLUS ONE TREAD LENGTH AND ON A HOROZONTAL PRANE AT 34" HT. (TYP. AT TOP AND FOOT OF ALL STARWAYS) 1 SALDER FULL HANNIG A LEAD CONTENT IN EXCESS OF 2/10 OF ONE PERCENT		SHOWERS / TUBS 1 SHOWER WILLS TO BE PINISED MIT CEMENT BOARD AND CERAMIC THE OF EQUAL TO CEIUNG 2 SHOWER ENCLOSURES SHALL BE SHOWER RODS, TEMPERED CLASS OR APPROVED 2 SHOWER ENCLOSURES SHALL BE WINNAUM 15" TO VERTICAL FACE OF WILLS AT SIDES LUMBER 1 ALL LIMBER MIST BEAR AN APPROVED CRAINNE STAMP 2 BEARNIC MILL BOTTOM PLATES SHALL BE TREATED OR FONDATION REDWOOD 3 RIE BLOCK STUD WALLS AT DROPPED CEIUNG, SOFTITS, AND AT MAXIMUM 10" MIEROME BEARING WALLS OVER 10" IN HIGHT TO BE MIN 265" AT 16" O.C. 4 INTEROME SEARING WALLS OVER 10" IN HIGHT TO BE MIN 265" AT 16" O.C.	CORROSON RESISTANT WEEP SCREED CORROSON RESISTANT WEEP SCREED A MINIMUM STRICK, ATRA-MENT FLANCE OF 3 1/2: A MINIMUM OF A" ABOVE FRISH CRADE R STUD WALLS A MINIMUM OF A" ABOVE FRISH CRADE T OPENABLE WITH AT WINDOWS SHALL BE 22" CLEAR WITH A NET T OPENABLE WITH AT WINDOWS SHALL BE 22" CLEAR WITH A NET T OPENABLE WITH AT WINDOWS SHALL BE 72" CLEAR WITH A NET T SPONGE FIT MINIMUM AT BEDROOMS WITHOUT BE ABOVE FINISHED FLOOR AND IN HAZARDOMS AREAS TEMPERED GLASS
RETURN AIR RECOPTAGE PIT RECEPTAGE RECOPTAGE R		DESIGN CRITERIA DESIGN CRITERIA DESIGN CRITERIA This plan has been prepared based on the following design criteria. Any devolution in requirements due to geographical, or jurisdiction is to be existed by a focal design professoral, itemsed to profice within that jurisdiction, who will make the necessary modifications and offix his seal. The condition of the crosts 15 LBS Dead food (flat roots) 15 LBS Dead food (flat roots) 25 LBS Minimum Footing Depth 18° into undisturbed soil or engineered tested fill per the engineer's report. 1500 PSF to be writted by a geo-technical report.	SEISMIC ZONE SEISMIC ZONE SEISMIC ZONE SEISMIC ZONE C N) DESIGN AND CONSTRUCT TO MEET REQUIREMENTS OF ZONE C B) ZONE FACTOR, Z=0.075 CONSTRUCTION SHALL COMPLY WITH THE FOLLOWING CODES AND AMENOMENT PER THER ADDPTING GORDMANCE: PER THER ADDPTING GORDMANCE: 2012 International Badding Code 2012 International Residentia Code or IECC(least restrictive) 2012 International Fixe Code	CELING JOSTS SHALL BE DOUGAS FIR LARCH MUBER 2 OR BETTER RIPPER/BUILT—UP ROOF JOIST NOTE 1. WHER RIPPERS ARE ATTACHED TO TOP OF ROOF JOSTS (1e TO OBTAIN SLOPE FOR DRAINAST, THE RIPPERS SHALL BE MULED TO THE JOSTS WITH 164 AT 24* OC. WHEN THE RIPPERS SHALL BE MULED TO THE JOSTS WITH 164 AT 24* OC. WHEN THE RIPPERS SHALL BE MULED TO THE JOSTS WITH 164 AT 24* OC. WHEN THE RIPPERS SHALL BE MULED TO THE JOSTS AT 40°C (MANUMA) STAGGERD BETWEEN SIDES EACH CLEAN SHALL BE SECURED WITH 4 6d (MINMAN), Z NITO THE JOSTS MOD 2 NITO THE RIPPERS ARE JUSTS TO THE JOSTS MOD 2 NITO THE RIPPERS SHALL NOT RAIN PERSHOULLAR TO JAMAN FRAMING MEMBERS, IF RIPPERS SHALL STAMP—STEP IN HEIGHT.	SHELL WANTER ACTED AND SMILAR GADD FLOOR LEVELS. SES FOR ND CONTROL SHALL BROTHER APPROVED 1. SHALL BE MAINTAINED. SPACING MAX SPAN 16° 0.0 18°-0° SPACING MAX SPAN 16° 0.0 22′ 11°	NG
				Design Originals is A Professional Building Design rim. We Are Not Qualified To Nor Licensed To Design rim. We Are Not Qualified To Nor Licensed Professional Industrial Framing Or Foundations. A Licensed Professional And General Studies Be Consulted Respecting The Framing On The Professional Noviga An Engineer's Sand She Fresent On The Responsible For The Structural Design Objects. By Fig. 18. Supposed to the Professional Control Control Design Objects of Control Professional Control Design On Any Woy/Or Any Problems Which My Arise.	2. TEMPERATURE CONTROLS READS FOR BLANKING MR AND WHILE STSTEMS. 7. TEMPERATURE CONTROLS FOR ELON SPARATE HVAC SYSTEMS AS FOLLOWS: a. THERMISTAN RECURRED FOR ELON SPARATE HVAC SYSTEMS AS FOLLOWS: - HARMIST MR VIT — ST DICRETES F TO 35 DEGREES F — CONJUNG ONLY — 70 DEGREES F TO 35 DEGREES F — HARMIST ACCOUNTS — TO DEGREES F TO 35 DEGREES F — HARMIST ACCOUNTS — SECRETIS FOLLOWS SHOT-OFF HVAC INPUT TO ELON ZONE OR FLOOR. - HARMIST CAN BE MET HEALD STAN MIST FOR FROM THE FROM THROWS ON WHEN HEALD READS HOS DEGREES F OR CHILLED - REQUIRED IN HICKOMOTIONED SPACES COUNTING FLUIDS ABOVE TOS DEGREES F OR CHILLED - SEWEL HALTES WHI ME STREAM STORES MUST HARE HALT TRAP ON BOTH MAET & COULT IN MEST HALTES WHI METRICAL HALT TRAP OF PART OF CHOSULATION SYSTEMS AND PRESSED MUST HARE HALT THAN THE SYSTEMS MUST HARE HALTES AND PRESSED MUST HARE HALTES AND PRESSED MUST HARE HALT THAN THE SYSTEMS MUST HARE HALTES AND PRESSED MUST HARE MUST HER MANUAL CONTROLS AND PRESSED MUST HAVE MUST HER MU	LENDER PARTICIPATION N. A. NATIONALLY RECOGNIZED THROU PARTY EMERCY PROGRAM WILL BE ACCEPTED AS COMPLIANCE WITH THE REQUIREMENTS FOR THE EMERCY PROGRAM WILL BE RECEIVED AT CHEST PARTY EMERCY PROGRAM WILL BE REGIFED AT THE SES PAREL AND WILL BE REGIFED AT THE FE FAUL INSPECTION OF THE DWELLING. 2. ARL LEXANCE: a. ALL OPERIOSS IN BUILDING CHRECOPE MUST BE SEALED b. RECESSED LIGHTS THE IC RATED 0.5' FORM COMB & 3' FROM INSULATION J. SOLAR HEAT GAN COEFFICIENT. c. NALIFERMALS AND OFFICIAL PROME MANY. EMERIONE WATER HEATING C. NALIFERMALS & ECOUP MUST BE RISTRICTOR HAVE & SERVET WATER HEATING C. NALIFERMALS AND RESULTION HEFORICAN MAY BE RECORDED TO BRYWALL OR AN INSTALLATION C. REPARALL INSULATION HEFOCINON MAY BE RECORDED TO BRYWALL OR AN INSTALLATION C. SUPER Y MUST — INSULATION RE-VALUE = 8 D. RETIRAN-LAR DUCTS — NSULATION RE-VALUE = 8 D. RETIRAN-LAR DUCTS — NSULATION MAY BE RECORDED TO BRYWALL OR AN INSTALLATION C. SUPERMALS—UNITED SUPPORTED LEXEN TO BE SECURELY FASTENED WITH WELDS, GASKETS, MASTIC-PULS-GRADDED-FRIGENCY MAY BE RECORDED TO BE SUPPORTED LEXEN OF THE PER MANNE, SPECS C. DOUGHS OUTS MITH EXTENDED HEADY MASTER, CARRET WAS THE PER MANNE, SPECS C. DOUGH DUCTS WITH EXTENDED HEADY MAY MAY DESCRIBED WITH WEDGE CASKETS, LAR FLIESS REQUIRED IN REMINER-LAR. LAR FLIESS REQUIRED LIKEWING—UNITED—UNITED—TO THE MAY NOT THE MAY NOT THE PER MANNE, SPECS C. DOUGH DUCTS WITH EXTENDED HEADY MAY NOT THE WEBS THE MAY NOT THE WEBS THE MAY NOT THE MED OF THE PER MANNE, SPECS C. DOUGH DUCTS WITH EXTENDED HEADY MAY NOT THE MED OF THE MED OF THE MAY NOT THE MED OF THE




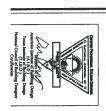








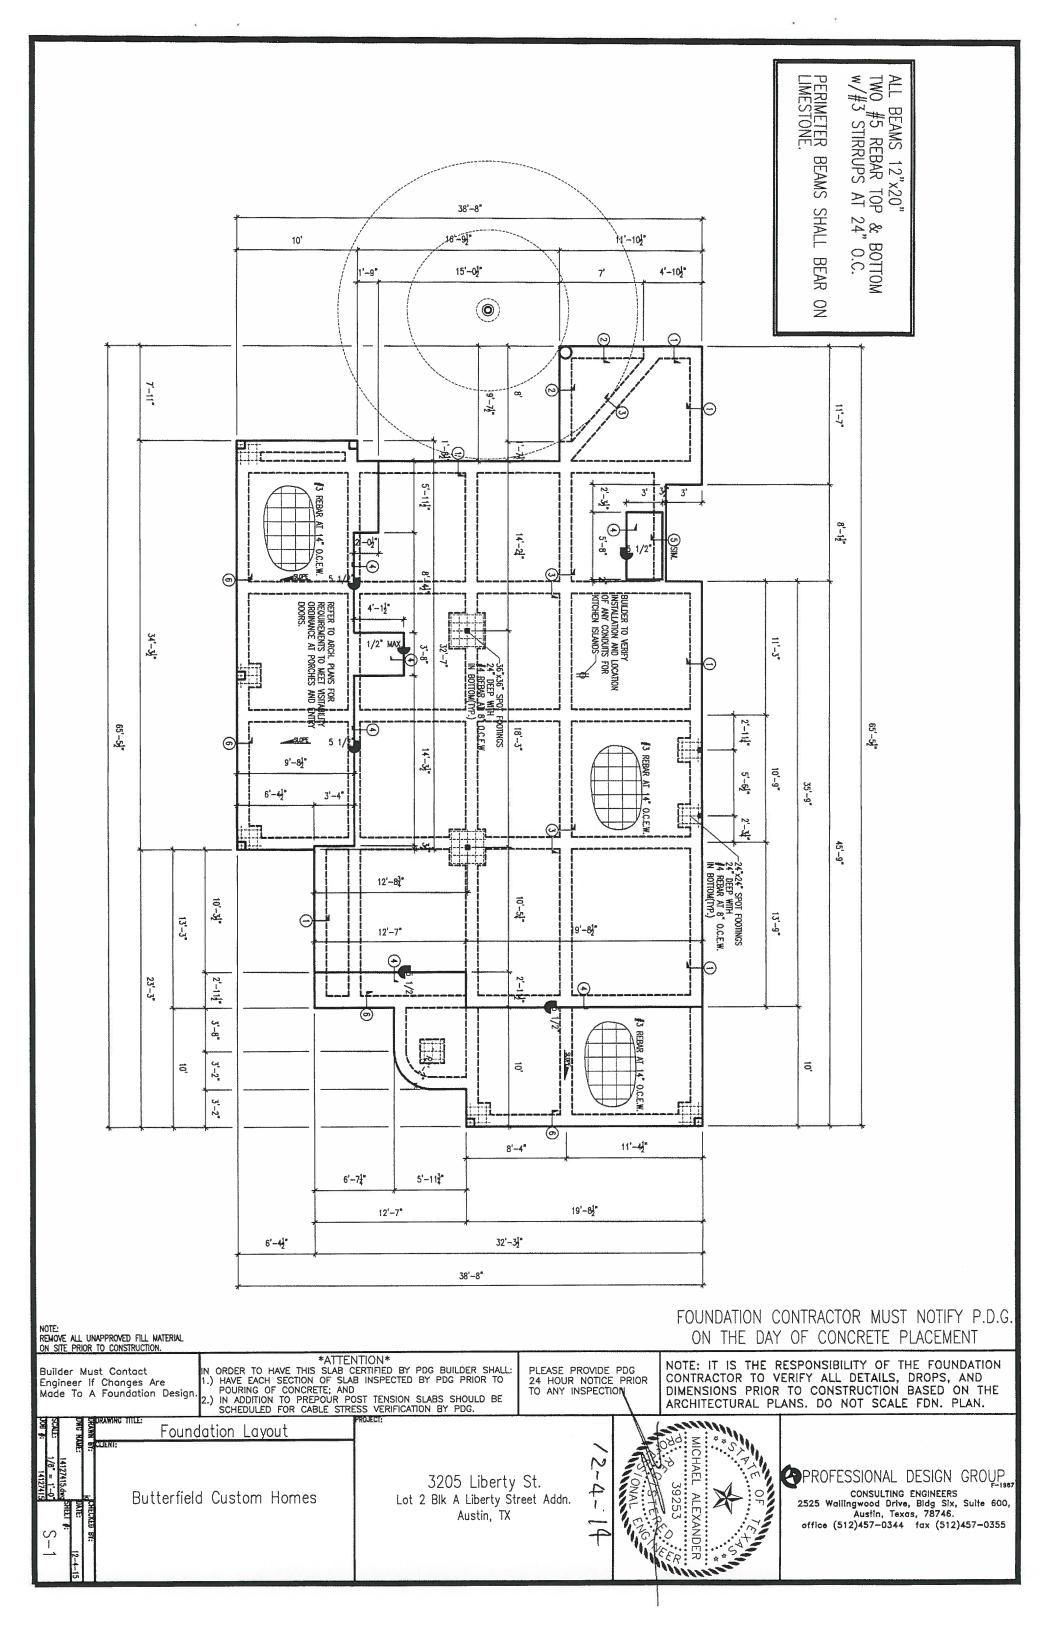

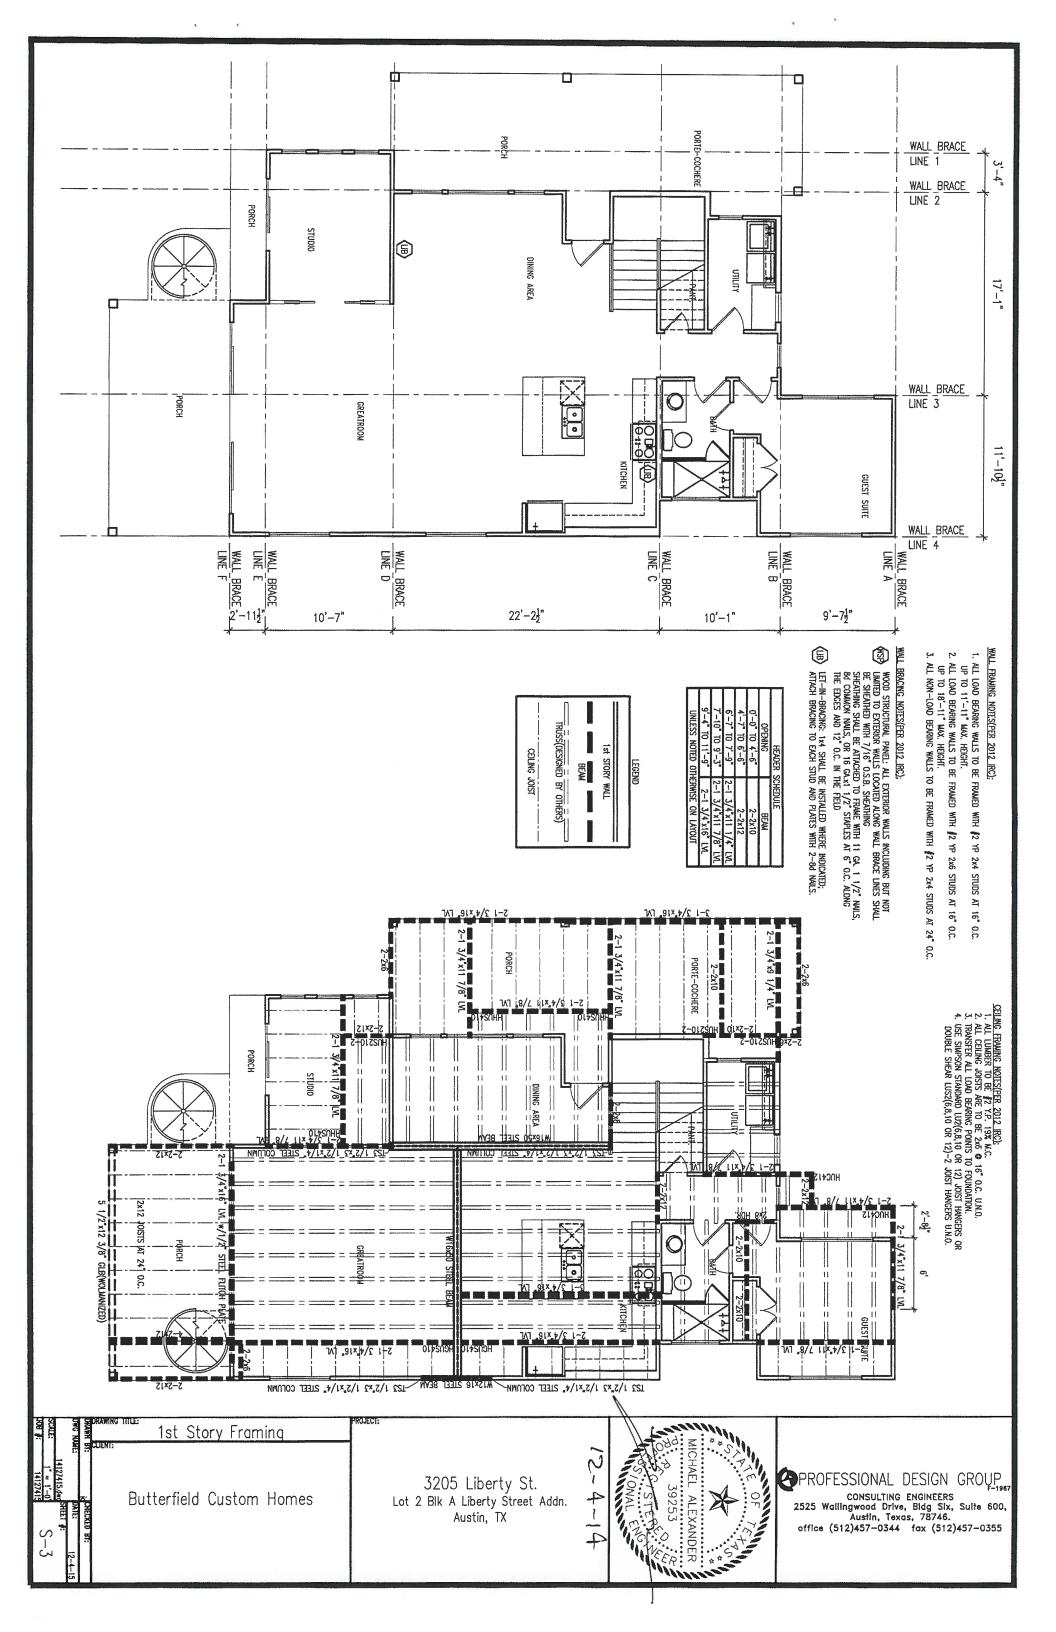

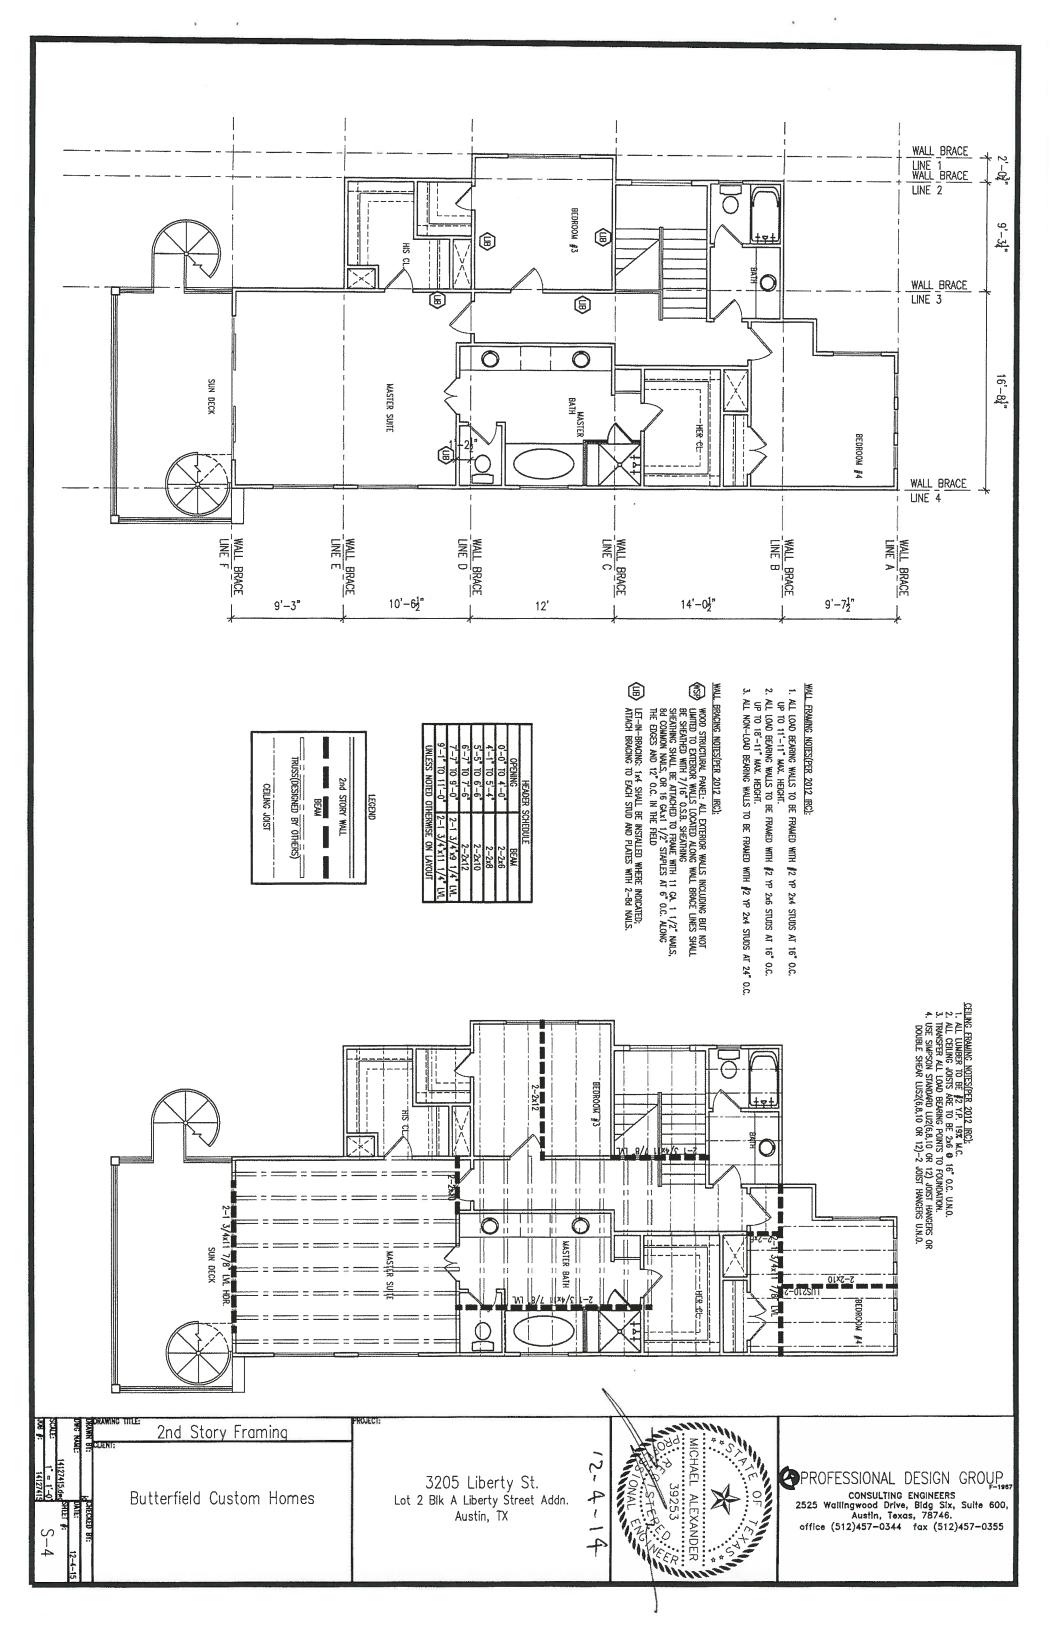

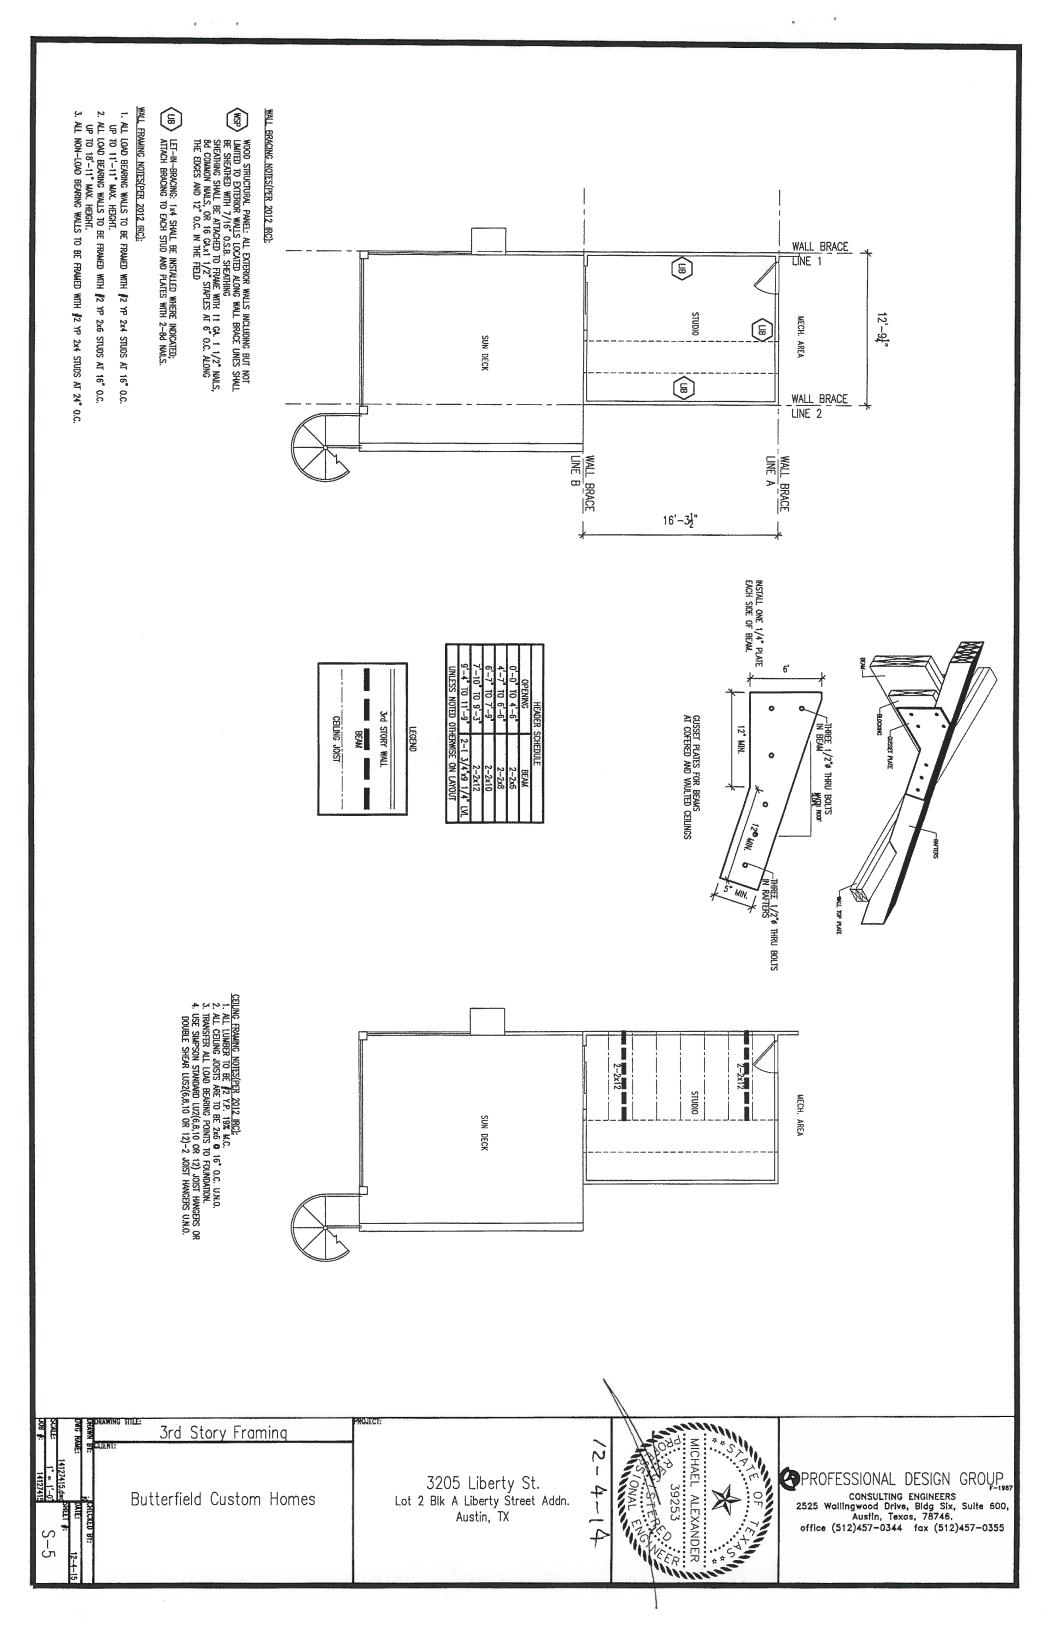

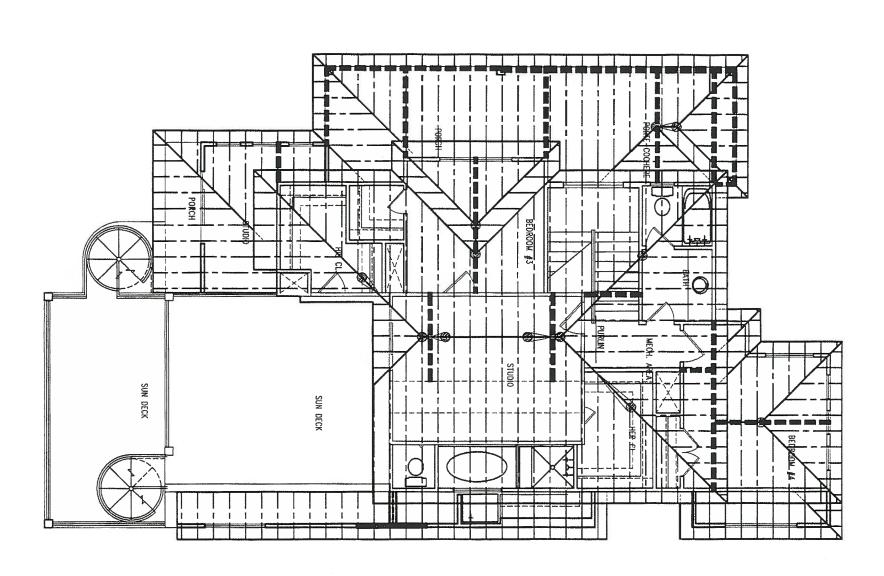

ROOF FRAMING NOTES[PER 2012 IRC]:

1. ALL LUMBER TO BE \$\frac{1}{2}\text{ Y.P. 193' M.C.}

2. ALL RATTERS ARE TO BE 2x6 \(\text{ 16" O.C. U.N.O.} \)

FOR A TILE ROOF.

3. ALL HIPS, RIDGES AND VALLEYS TO BE ONE MILL SIZE LARGER THAN THE RATTERS THEY ARE SUPPORTING U.N.O.

4. PROVIDE COLLAR TIES \(\text{ 4'-0" O.C. ON ALL RAFTERS.} \)

5. TRANSFER ALL LOAD BEARING POINTS TO FOUNDATION.

6. BRACE HIPS, RIDGES AND VALLEYS AS SHOWN.

7. ALL RAFTER SPLICES SHALL BE BRACED.

8. PURLINS ARE TO BE SAME DEPTH AS RAFTERS THEY ARE SUPPORTING.


9. BRACE PURLINS \(\text{ 4'-0" O.C. DOWN TO WALLS OR BEAMS BELOW.}

10. ALL TRUSSES TO BE DESIGNED BY TRUSS MANUFACTURER.

11. \(\text{ 11.} \)

11. \(\text{ MONICATES TYPICAL RIDGE/HIP/VALLEY BRACING.} \)

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Roof Framing Roof Framing Rough Butterfield Custom Homes S-6	3205 Liberty St. Lot 2 Blk A Liberty Street Addn. Austin, TX	MICHAEL ALEXANDER 39253 39253 39253 39253 39253 39253 39253 39253 39253 39253	PROFESSIONAL DESIGN GROUP CONSULTING ENGINEERS 2525 Wallingwood Drive, Bldg Six, Suite 600, Austin, Texas, 78746, office (512)457-0344 fax (512)457-0355

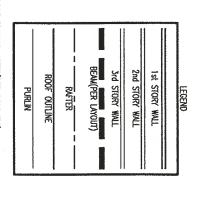